CVS PHARMACY NWC LINCOLN WAY EAST AND WALES ROAD CITY OF MASSILLON COUNTY OF STARK, STATE OF OHIO

State Ave Ne PROJECT SITE

PROJECT SITE

SITE CONTEXT MAP

NOT TO SCALE

OEPA STORM WATER GENERAL PERMIT NUMBER: 3GC04846*AG

APPROVALS

APPROVED BY THE MASSILLON CITY ENGINEER THIS DAY
OF APPL , 2010.

KEITH A. DYLEWSKI, PE

DATE

ONLY APPROVED SIGNED PLANS BY THE CITY ENGINEER ARE TO BE USED FOR CONSTRUCTION.

UTILITY SOURCES

GAS: DOMINION EAST OHIO DENIS KULP 330-664-2439

WATER:
AQUA OHIO, INC.
DONALD SNYDER
330-832-7600, EXT. 205
STARK REGIONAL DIVISION
870 THIRD STREET, NW
MASSILLON, OH 44647-4206

ELECTRIC:
OHIO EDISON - FIRST ENERGY
KEVIN S. MCCLUSKY
330-830-7085
MASSILLON SERVICE BUILDING
2600 ERIE STREET, SOUTH
MASSILLON, OH 44646

TELEPHONE: AT&T THOMAS HOBART 330-384-2078 MASSILLON BUILDING DEPARTMENT:
WILLIAM L. KRAFT
151 LINCOLN WAY EAST
MASSILLON, OH 44646
330-830-1724

SANITARY AND STORM SEWER
MASSILLON ENGINEERING DEPARTMENT
KEITH DYLEWSKI, PE

TITLE SHEET.

ALTA SURVEY.

DEMOLITION AND EXISTING CONDITIONS PLAN.

C-2

SITE PLAN.

C-3

UTILITY PLAN.

C-4

PAVING, GRADING, DRAINAGE PLAN.

C-5

SWP3 PLAN.

C-6

SWP3 DETAILS.

C-7

CONSTRUCTION DETAILS.

LANDSCAPE PLAN (BY OTHERS).

IRRIGATION PLAN (BY OTHERS).

IRRIGATION PLAN (BY OTHERS).


I-1

THRU I-2


INDEX OF SHEETS:

THIS PROJECT IS LOCATED IN FLOOD ZONE C



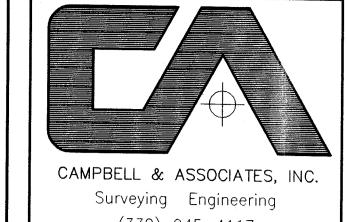

Surveying Engineering (330) 945—4117 1923 Bailey Road Suite A Cuyahoga Falls, Ohio 44221 WWW.CAMPBELLSURVEY.COM

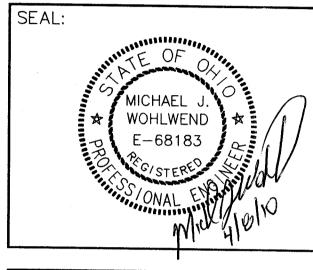



STORE NUMBER:

NWC LINCOLN WAY EAST AND WALES ROAD MASSILLON, OHIO (STARK COUNTY)

DEAL TYPE:

DEVELOPER: 14600 DETROIT AVENUE LAKEWOOD, OHIO 44107 (216) 221-6600



REVISIONS:	
BID SET .	2010-02-0
ADDENDUM 2	2010-02-2
BULLETIN BZ	2010-04-0

LAYOUT COORD:
PLANNING MGR.

DRAWING BY:

DATE:

2010-01-11


JOB NUMBER:

20090146

TITLE SHEET

SHEET NUMBER:

C-1

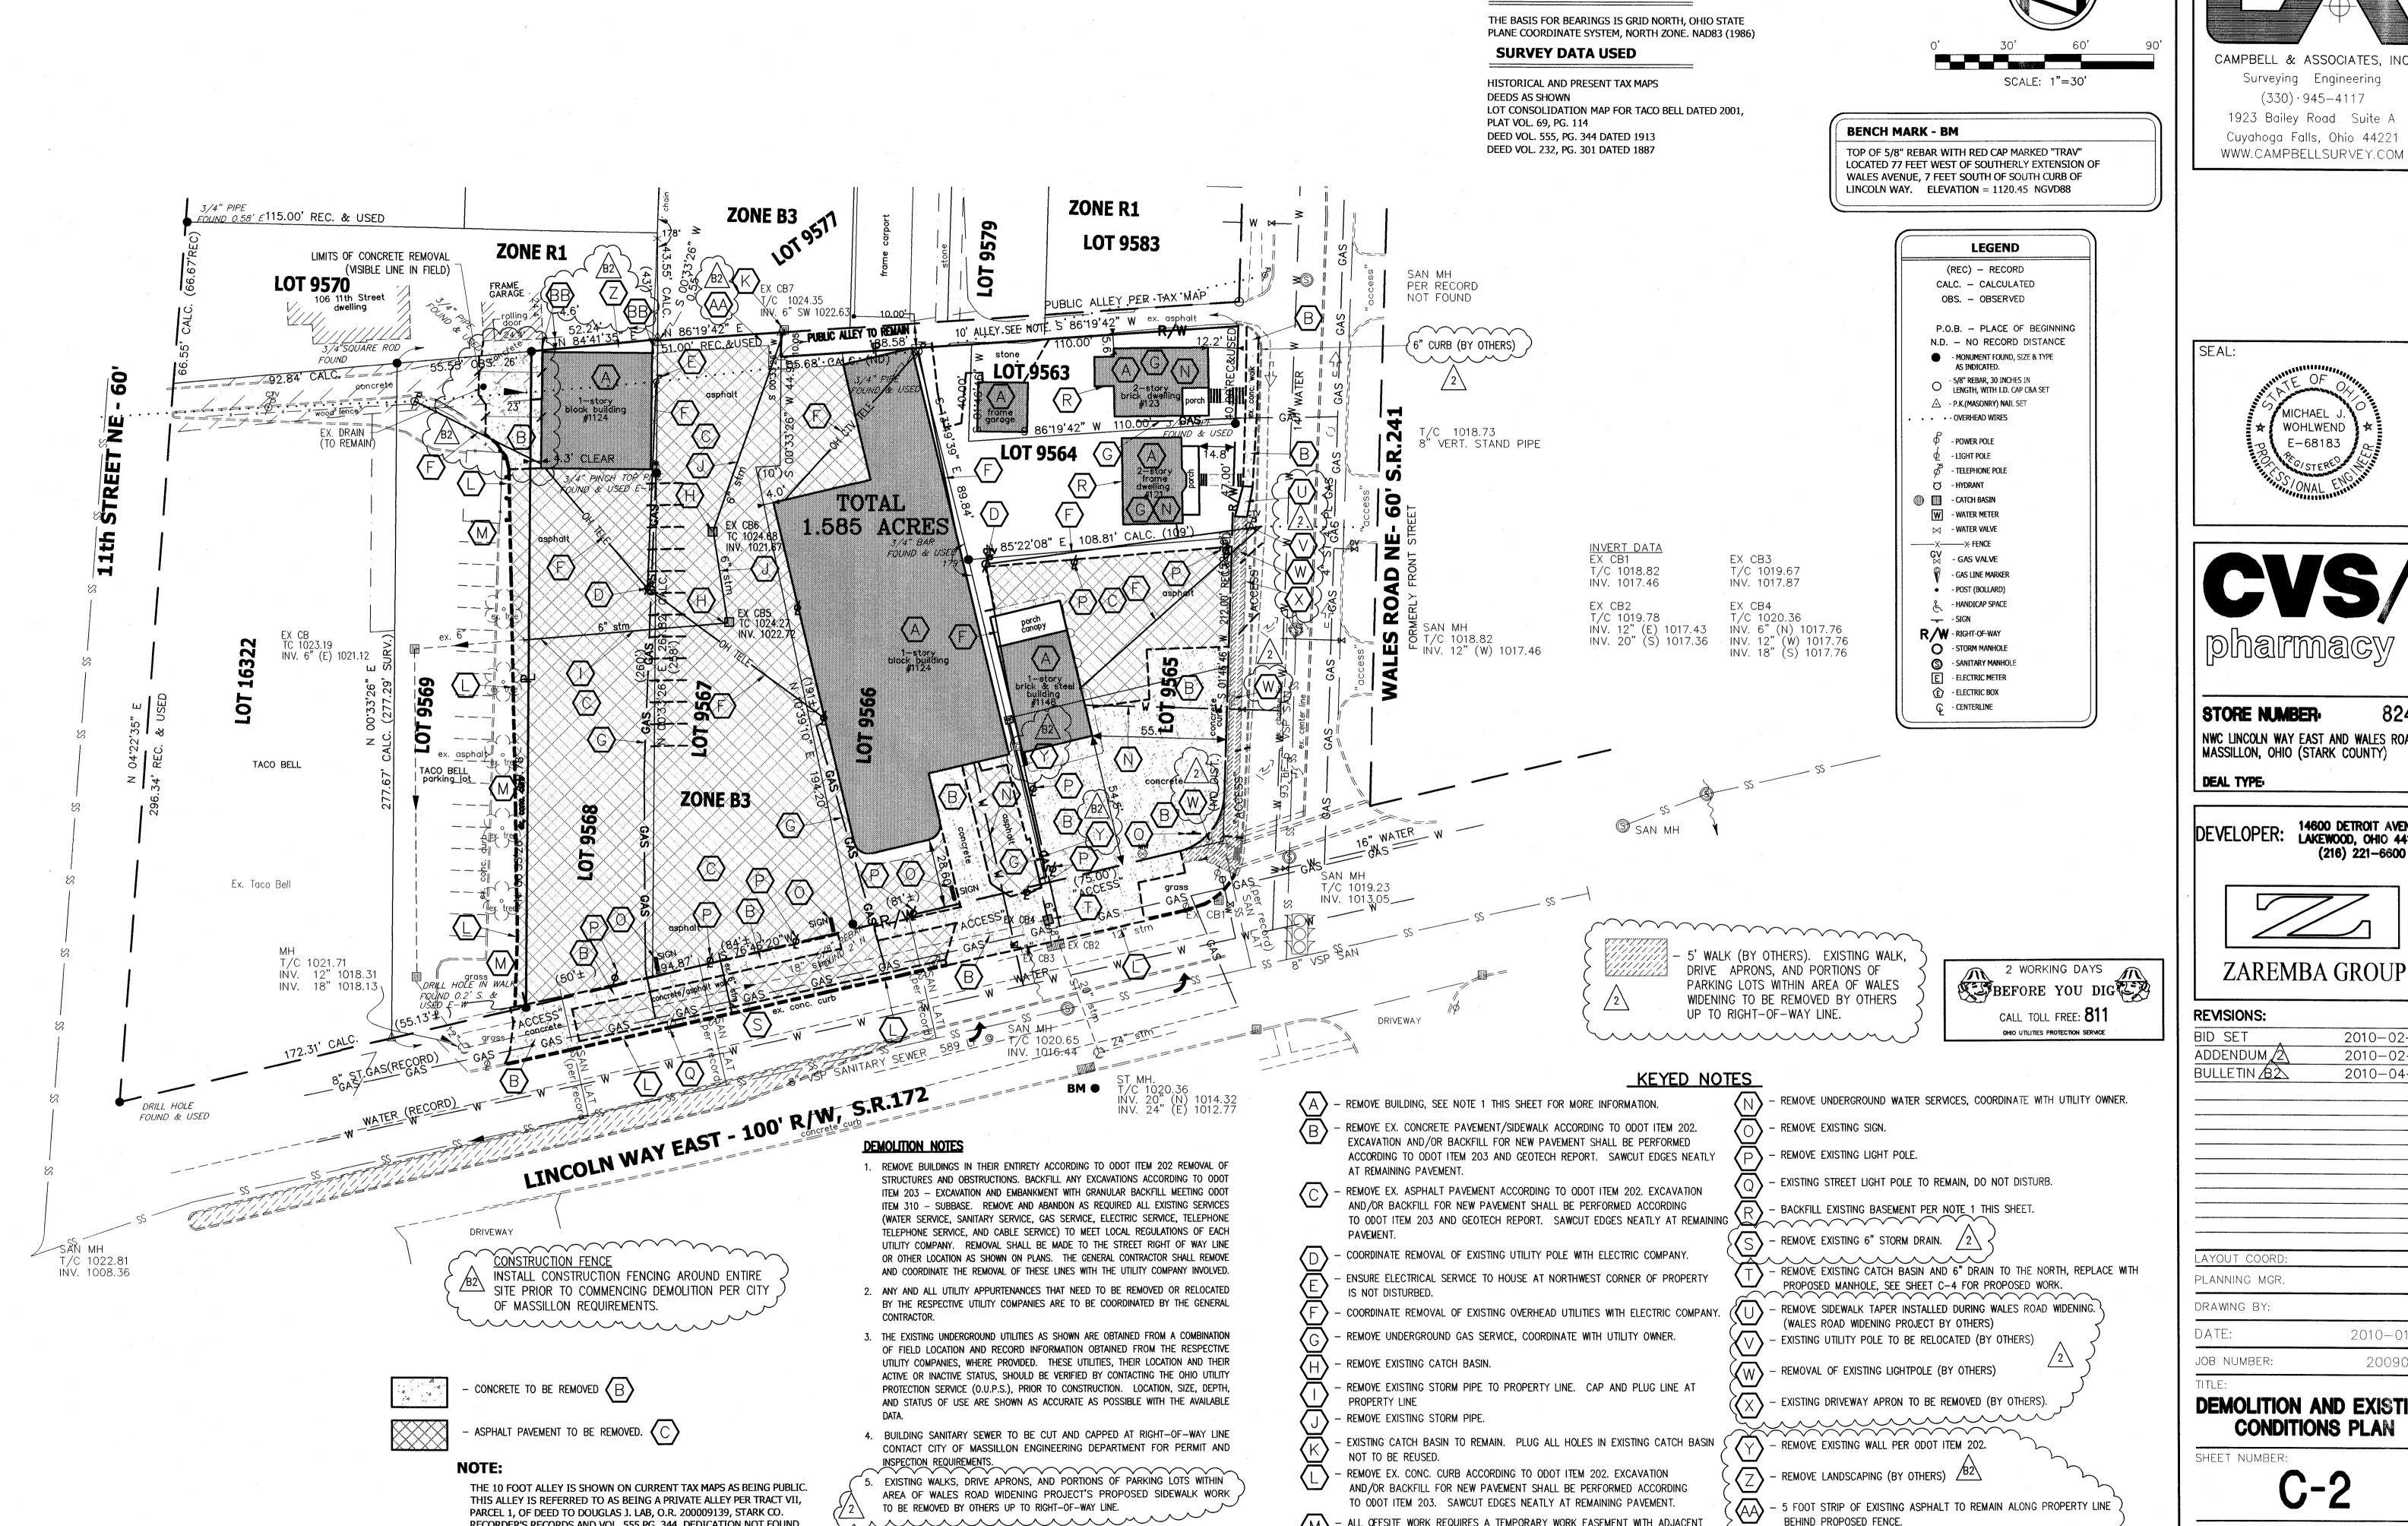



TO BE REMOVED BY OTHERS UP TO RIGHT-OF-WAY LINE.

PARCEL 1, OF DEED TO DOUGLAS J. LAB, O.R. 200009139, STARK CO.

RECORDER'S RECORDS AND VOL. 555,PG. 344. DEDICATION NOT FOUND.

BASIS OF BEARINGS

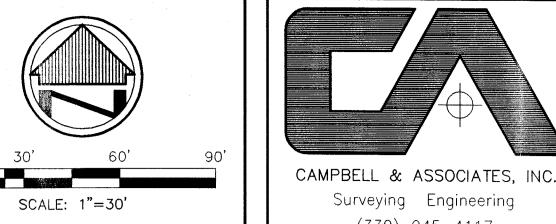

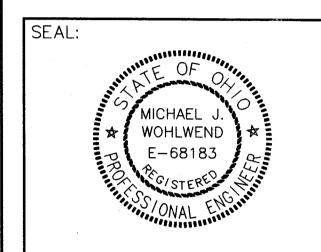

STORE NUMBER.

NWC LINCOLN WAY EAST AND WALES ROAD MASSILLON, OHIO (STARK COUNTY)

14600 DETROIT AVENUE DEVELOPER: LAKEWOOD, OHIO 44107 (216) 221-6600



	BID SET	2010-02-08
	ADDENDUM 2	2010-02-26
	BULLETIN B	2010-04-06
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DEMOLITION AND EXISTING

2010-01-11

20090146


COMMENTS:

BEHIND PROPOSED FENCE.

PROPERTY OWNER. NO OFFSITE WORK SHALL COMMENCE UNTIL TEMPORARY WORK - REMOVE EXISTING FENCE AS NECESSARY TO INSTALL PROPOSED FENCE.


ALL OFFSITE WORK REQUIRES A TEMPORARY WORK EASEMENT WITH ADJACENT

EASEMENT IS OBTAINED.

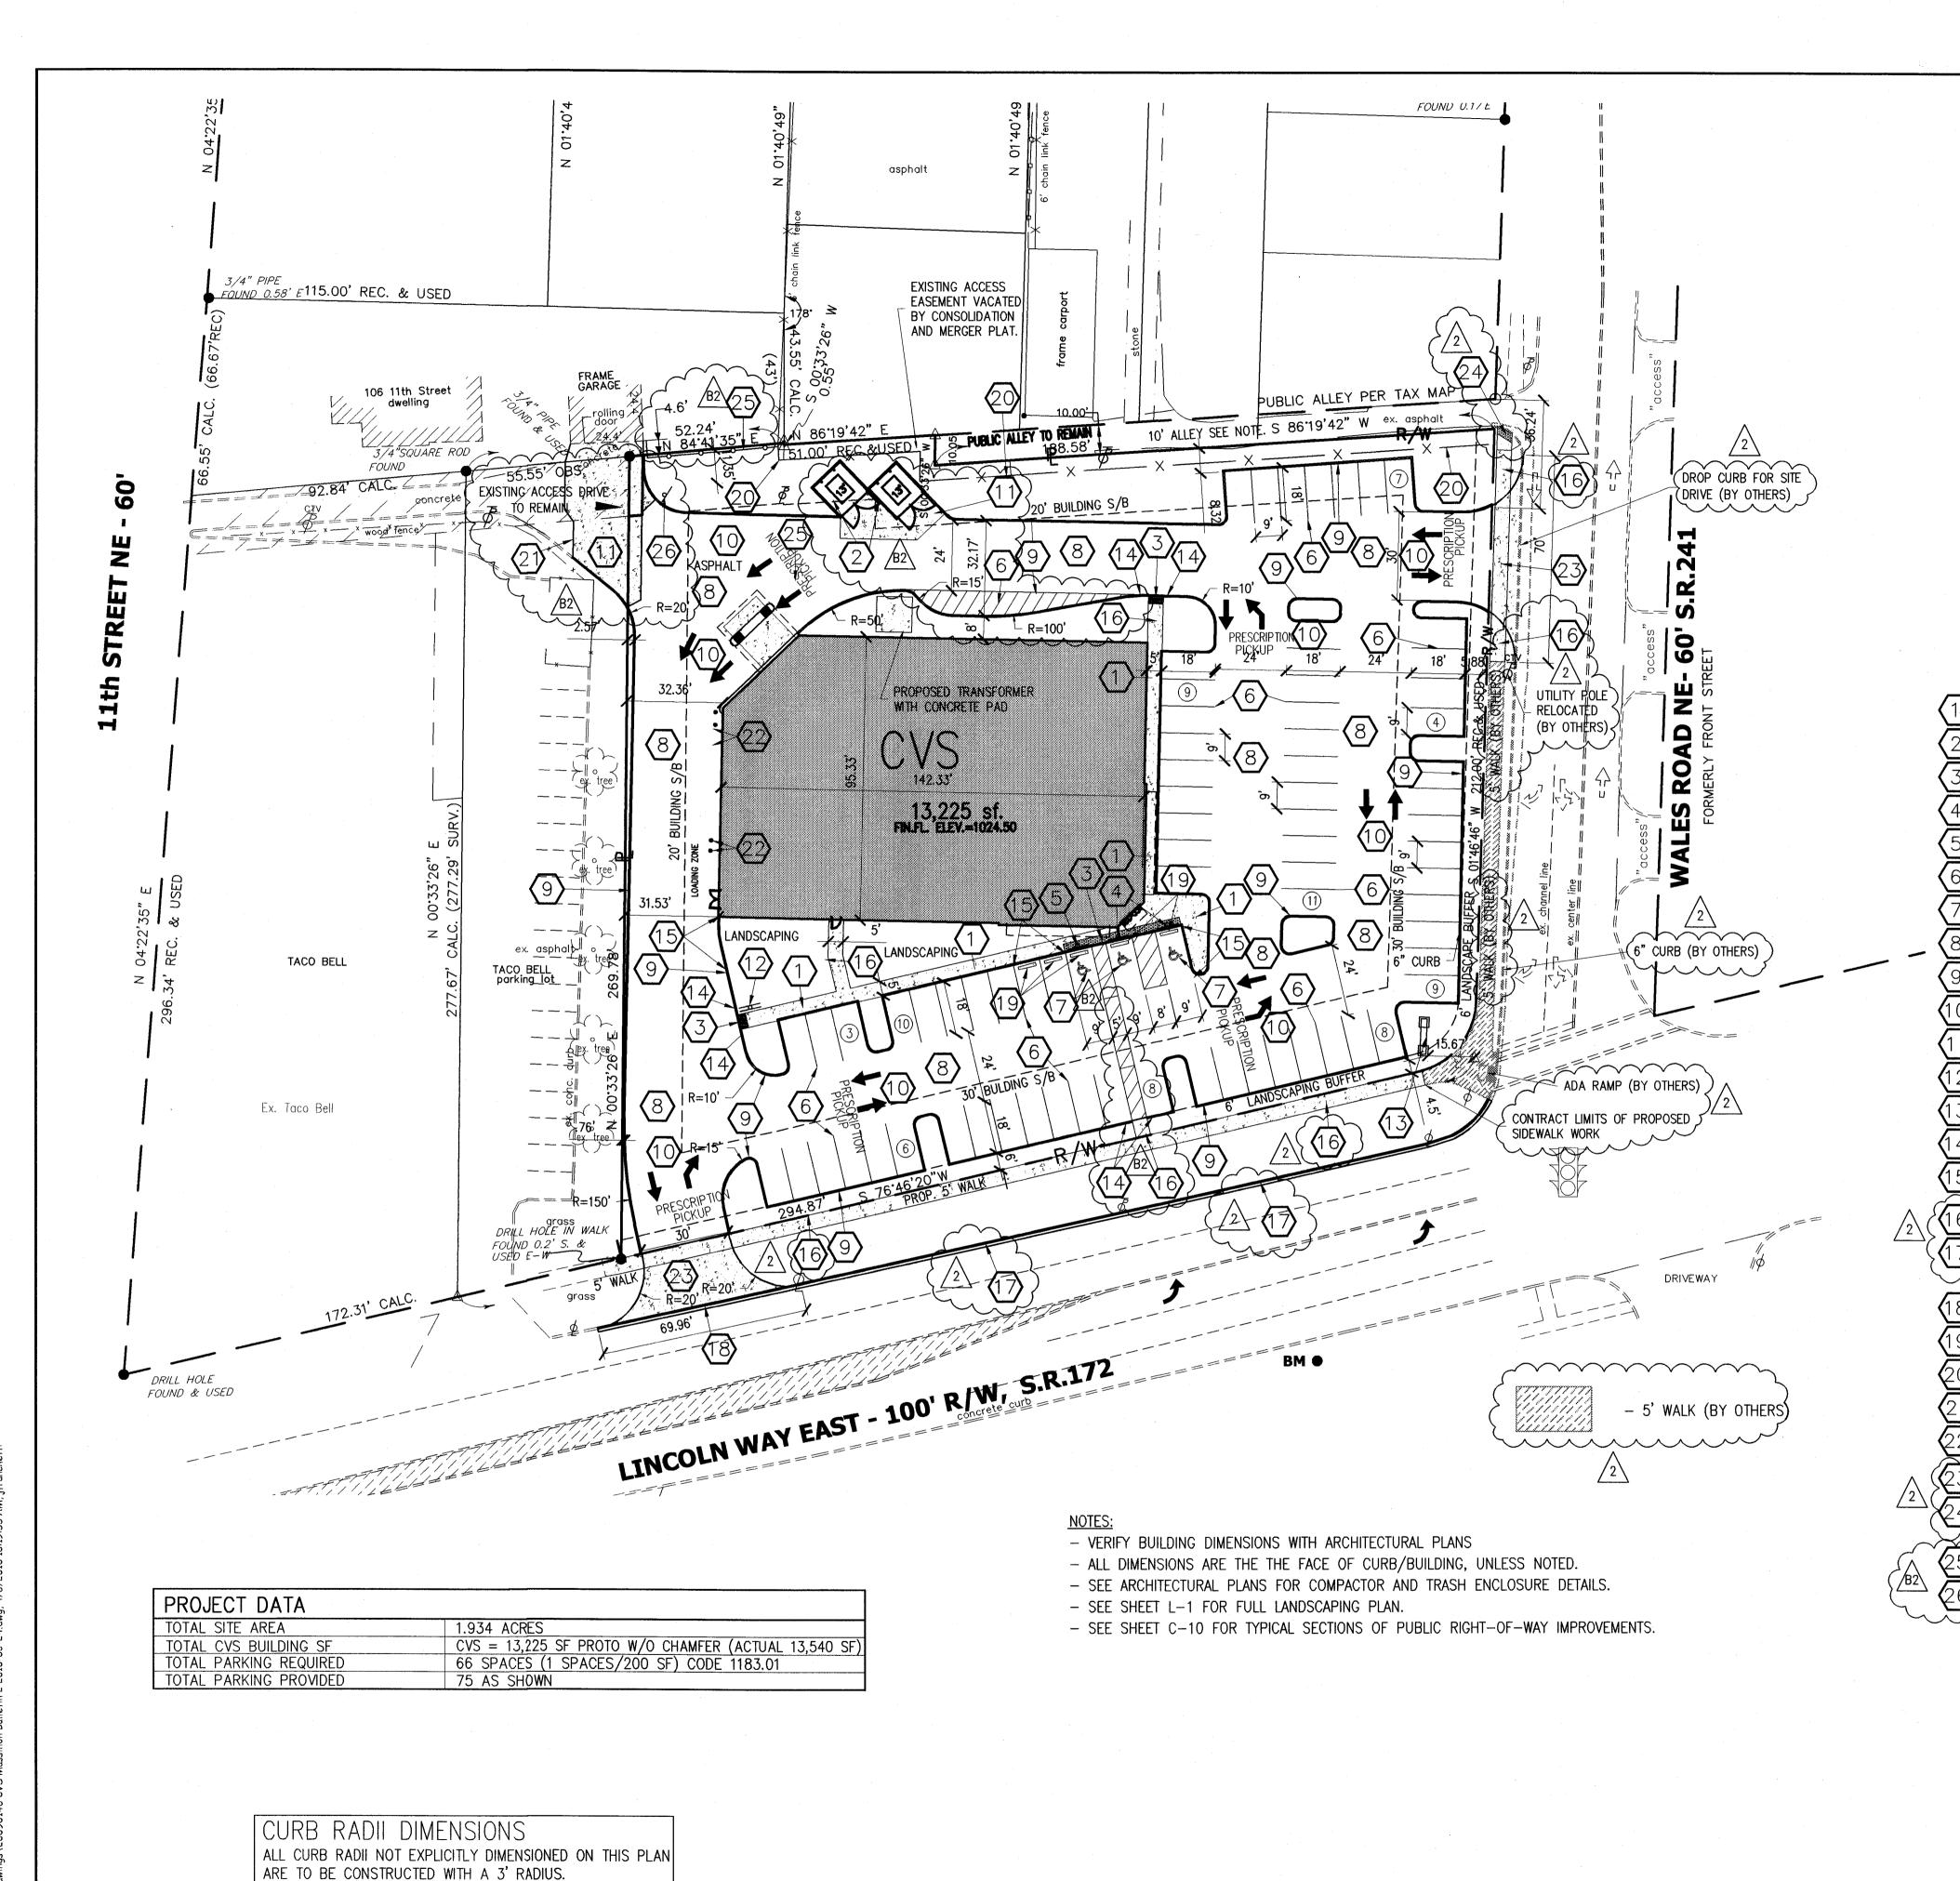

BENCH MARK - BM

TOP OF 5/8" REBAR WITH RED CAP MARKED "TRAV" LOCATED 77 FEET WEST OF SOUTHERLY EXTENSION OF WALES AVENUE, 7 FEET SOUTH OF SOUTH CURB OF LINCOLN WAY. ELEVATION = 1120.45 NGVD88

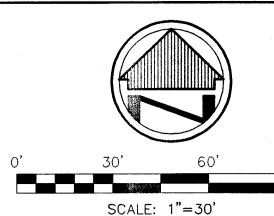

BASIS OF BEARINGS

THE BASIS FOR BEARINGS IS GRID NORTH, OHIO STATE PLANE COORDINATE SYSTEM, NORTH ZONE. NAD83 (1986)

SURVEY DATA USED

HISTORICAL AND PRESENT TAX MAPS **DEEDS AS SHOWN** LOT CONSOLIDATION MAP FOR TACO BELL DATED 2001, PLAT VOL. 69, PG. 114 DEED VOL. 555, PG. 344 DATED 1913 DEED VOL. 232, PG. 301 DATED 1887

KEYED NOTES

- INSTALL INTEGRAL CURB AND WALK. SEE DETAIL SHEET C-8. SEE SHEET C-5 FOR CURB HEIGHT.

- DUMPSTER/COMPACTOR ENCLOSURE, SEE ARCH. PLANS FOR DETAILS. SIDEWALK TO BE FLUSH WITH PAVEMENT, INSTALL DETECTABLE

PAVERS, SEE DETAIL SHEET C-9. INSTALL HANDICAP & VAN ACCESSIBLE SIGNS, TYPICAL 2 PLACES.

SEE DETAIL SHEET C-8.

INSTALL HANDICAP SIGNS, TYPICAL 1 PLACE. SEE DETAIL SHEET C-8.

- PAVEMENT STRIPING SHALL BE WHITE, 4" WIDE PER ODOT ITEM 640.

 INSTALL HANDICAP PAVEMENT MARKING, TYPICAL 3 PLACES. SEE DETAIL SHEET C-8. - INSTALL ASPHALT PAVEMENT, SEE DETAIL SHEET C-8.

INSTALL CONCRETE TYPE 6 CURBING, SEE DETAIL SHEET C-8.

4" WIDE WHITE DIRECTIONAL ARROWS, & "PRESCRIPTION PICKUP" MARKINGS, PER ODOT ITEM 640, AS SHOWN ON PLAN.

INSTALL CONCRETE PAVEMENT/APRON, SEE DETAIL SHEET C-8.

"DO NOT ENTER" AND "STOP" SIGNAGE MOUNTED ON SAME POLE BACK TO BACK, TYPICAL 2 PLACES, SEE DETAIL, SHEET C-9.

INSTALL MONUMENT SIGN, SEE SIGN VENDOR AND ARCHITECTURA PLANS FOR DETAILS.

14 - TAPER END OF CURB FROM 6" TO 0" IN 2'.

TAPER CURB REVEAL FROM 6" TO 0" IN 18'.

- INSTALL 5' WIDE SIDEWALK, PER CITY OF MASSILLON SPECIFICATIONS. SEE DETAIL SHEET C-8 AND TYPICAL SECTION ON SHEET C-10. 1

- INSTALL ODOT TYPE 6 CURB, PER CITY OF MASSILLON SPECIFICATIONS. SEE DETAIL SHEET C-8 AND TYPICAL SECTION ON SHEET C-10.
REPLACE PAVEMENT AS NECESSARY. EXISTING PAVEMENT SHALL BE CUT IN NEAT, STRAIGHT LINES. AS THE CONTROL OF THE

(18) - INSTALL DROP CURB FOR PROPOSED CVS ENTRANCE PER CITY OF MASSILLON STANDARDS.

- INSTALL PARKING STOP, SEE DETAIL SHEET C-8 (5 TYPICAL)

- INSTALL PRIVACY FENCE, SEE DETAIL SHEET C-8. FENCE TO BE OFFSET FROM PROPERTY LINE 5.0'.

- PROVIDE NEAT AND EVEN JOINT BETWEEN PROPOSED ASPHALT AND EXISTING CONCRETE PAVEMENT.

- INSTALL BOLLARD, SEE DETAIL SHEET C-8. (4 TYPICAL)

- INSTALL CONCRETE DRIVE APRON AND 9" THICK SIDEWALK PER DETAIL SHEET C-10 AND CITY OF MASSILLON SPECIFICATIONS.

- INSTALL HANDICAP RAMP TYPE A1 WITH DETECTABLE WARNING PAVERS, SEE DETAIL SHEET C-9. PROVIDE CURB CUT FOR PROPOSED RAMP PER CITY OF MASSILLON SPECIFICATIONS. ^

- INSTALL PROPOSED FENCE TO MATCH FENCE ON ADJOINER'S PROPERTY. FENCE TO BE 1' OFFSET FROM PROPERTY LINE AS SHOWN ON PLANS. TIE PROPOSED FENCE INTO EXISTING FENCE ON ADJOINER'S PROPERTY.

LEGEND

REC. - RECORD DISTANCE OR ANGLE

CAL. – CALCULATED DISTANCE OR ANGLE

OBS. - OBSERVED DISTANCE OR ANGLE

T.P.O.B.— TRUE PLACE OF BEGINNING

P.O.B. - PLACE OF BEGINNING

- MONUMENT BOX

MONUMENT FOUND, SIZE
 TYPE AS INDICATED.

5/8" REBAR, 30 INCHES IN LENGTH, WITH I.D. CAP C&A SET.

- P.K.(MASONRY) NAIL SET

R/W - RIGHT-OF-WAY

E/P - EXISTING EDGE OF PAVEMENT

- PROPERTY LINE

CENTERLINE

POWER POLE

- LIGHT POLE - TELEPHONE/POWER POLE

DEVELOPER:

DEAL TYPE

STORE NUMBER

SEAL:

14600 DETROIT AVENUE LAKEWOOD, OHIO 44107 (216) 221-6600

NWC LINCOLNWAY EAST AND WALES ROAD

MASSILLON, OHIO (STARK COUNTY)

8248

CAMPBELL & ASSOCIATES, INC. Surveying Engineering

 $(330) \cdot 945 - 4117$

1923 Bailey Road Suite A

Cuyahoga Falls, Ohio 44221

WWW.CAMPBELLSURVEY.COM

WOHLWEND



REVISIONS:

ŀ	BID SET	2010-02-08
	ADDENDUM 2	2010-02-26
Ś	BULLETIN AS	2010-04-06
<		

LAYOUT COORD:

PLANNING MGR. DRAWING BY:

20090146

DATE: 2010-01-11 JOB NUMBER:

SITE PLAN

SHEET NUMBER:

COMMENTS:

NOTE:

THE 10 FOOT ALLEY IS SHOWN ON CURRENT TAX MAPS AS BEING PUBLIC. THIS ALLEY IS REFERRED TO AS BEING A PRIVATE ALLEY PER TRACT VII, PARCEL 1, OF DEED TO DOUGLAS J. LAB, O.R. 200009139, STARK CO. RECORDER'S RECORDS AND VOL. 555,PG. 344. DEDICATION NOT FOUND.

2 WORKING DAYS
BEFORE YOU DIG CALL TOLL FREE: 811 OHIO UTILITIES PROTECTION SERVICE

SCALE: 1"=30'

BASIS OF BEARINGS

THE BASIS FOR BEARINGS IS GRID NORTH, OHIO STATE PLANE COORDINATE SYSTEM, NORTH ZONE. NAD83 (1986) **SURVEY DATA USED**

HISTORICAL AND PRESENT TAX MAPS DEEDS AS SHOWN LOT CONSOLIDATION MAP FOR TACO BELL DATED 2001, PLAT VOL. 69, PG. 114

DEED VOL. 555, PG. 344 DATED 1913 DEED VOL. 232, PG. 301 DATED 1887 LEGEND

$ ot\!\!\!/ $	- TELEPHONE POLE
Ø	- HYDRANT
	- EX. CATCH BASIN
\bowtie	- WATER VALVE
X	- FENCE
GV ⋈	- GAS VALVE
R/W	- RIGHT-OF-WAY
Ŷ	- GAS LINE MARKER
9	- SANITARY MANHOLE
Ę	- CENTERLINE
	- EX. TELEPHONE LINE
(₁	- EX. GASLINE
SAN	- EX. SANITARY SEWER
— —ST— —	- EX. STORM SEWER
O/E	- EX. OVERHEAD UTILITY LINE.
W	- EX. WATERLINE
G	- PROP. GAS SERV.
—— <i>W</i> ——	- PROP. WATER SERV.
-E/T/CATV-	- PROP. ELEC, TEL & CATV
——SS——	- PROP. SANITARY LATERAL
10 St.	- PROP. CATCH BASIN (WITH UNDERDRAINS)

DOUBLE UTILITY CLEANOUT SEE BUILDING PLUMBING PLANS FOR DETAILS.

- PROP. SANITARY MANHOLE

- PROP. STORM MANHOLE

- PROP. DOWNSPOUT

- PAVEMENT & SIDEWALK REPAIR

- INSTALL DOMESTIC WATER METER AND FIRE LINE BACKFLOW DEVICES IN BUILDING, SEE BUILDING PLUMBING PLANS FOR DETAILS, COORDINATE WITH AQUA OHIO.

- REPAIR PAVEMENT, SEE DETAIL SHEET C-8. CONTRACTOR SHALL BE RESPONSIBLE FOR DEVELOPING MAINTENANCE OF TRAFFIC PLAN FOR PUBLIC ROADS, AND SHALL OBTAIN ALL ROAD OPENING PERMITS AND INSPECTION FROM CITY OF MASSILLON ENGINEERING DEPARTMENT REQUIRED TO INSTALL UTILITIES.

INSTALL ELECTRICAL SERVICE, COORDINATE WITH ELECTRIC PLANS, AND UTILITY OWNER.

INSTALL PROPOSED TELEPHONE SERVICE, COORDINATE WITH ELECTRICAL PLANS AND UTILITY OWNER.

- GAS SERVICE SHOWN FOR INFORMATIONAL PURPOSES ONLY. SERVICE WILL BE FIELD DESIGNED AND INSTALLED BY DOMINION EAST OHIO. CONTRACTOR TO COORDINATE SCHEDULE WITH DOMINION.

- INSTALL TAPPING SLEEVE AND VALVE, PER AQUA OHIO WATER SPECIFICATIONS. SIZE OF EXISTING MAIN IS UNKNOWN DUE TO MULTIPLE MAPS, (LIKELY TO BE 8" OR 14") VERIFY SIZE IN FIELD.

- 7 LF 6" STM @ 1.00% MIN. FOR DOWNSPOUT CONNECTIONS.

- 19 LF 6" STM ♥ 1.00% MIN. FOR DOWNSPOUT CONNECTIONS.

- 21 LF 6" STM @ 1.00% MIN. FOR DOWNSPOUT CONNECTIONS.

- INSTALL 6" GATE VALVE AND 6" COMBINED WATER SERVICE PER AQUA OHIO STANDARDS AND SPECIFICATIONS.

- INSTALL 2" WATER SERVICE WITH SHUT OFF VALVE PER AQUA OHIO STANDARDS.


INSTALL 6" FIRE LINE PER AQUA OHIO STANDARDS.

- INSTALL 6" SANITARY SERVICE PER CITY OF MASSILLON STANDARDS AND SPECIFICATIONS.

- MODIFY EXISTING CATCH BASIN AS NECESSARY TO RECEIVE PROPOSED 8" PIPE.


- INSTALL PROPOSED MANHOLE IN PLACE OF EXISTING CATCH BASIN. RECONNECT EXISTING 18" PIPES FROM W AND S TO PROPOSED MANHOLE.

STRUCTURE	TOP	INV. IN	INV. OUT	SIZE	LENGTH	% SLOPE	DESCRIPTION
1	1023.55		1021.05				ODOT 2-2B MODIFIED (SEE DETAIL SHEET C-8)
				12	80	0.32	
2	1023.75	1020.79	1020.79				ODOT 2-2B MODIFIED (SEE DETAIL SHEET C-8)
				12	123	1.50	
3	1021.50	1018.95	1018.70				ODOT 2-2B MODIFIED (SEE DETAIL SHEET C-8)
	1000.00	4040.40	1010 10	15	76	0.32	
4	1022.00	1018.46	1018.46				ODOT 2-2B MODIFIED (SEE DETAIL SHEET C-8)
	1000.05	1010.07	1010.07	15	72	0.32	
5	1022.25	1018.23	1018.23				ODOT 2-2B MODIFIED (SEE DETAIL SHEET C-8)
10	1000.00	1010.07	ļ	15	62	0.32	
12	1022.00	1018.03					TYPE 3 MANHOLE (SEE SHEET C-10)
EX7	1024.35		1000.67				FWOTING OATOU DACIN
L//	1024.33		1022.63	8	42	4.33	EXISTING CATCH BASIN
6	1023.00	1020.81	1020.48	0	42	4.33	ODOT O OD MODIFIED (CEE DETAIL CHEET O D)
	1023.00	1020.01	1020.40	12	145	1.00	ODOT 2-2B MODIFIED (SEE DETAIL SHEET C-8)
7	1021.60	1019.03	1019.03	12	143	1.00	ODOT 2 20 MODIFIED (SEE DETAIL SHEET C 8)
	1021.00	1013.00	1019.03	12	54	0.40	ODOT 2-2B MODIFIED (SEE DETAIL SHEET C-8)
8	1021.50	1018.81	1018.56	12	34	0.40	ODOT 2-2B MODIFIED (SEE DETAIL SHEET C-8)
	1021.00	1010.01	1010.30	15	91	0.40	ODOT 2-28 MODIFIED (SEE DETAIL SHEET C-8)
10	1022.75	1018.20			31	0.40	TYPE 3 MANHOLE (SEE SHEET C-10)
		1010.20		· · · · · · · · · · · · · · · · · · ·			THE S WANTOLE (SEE SHEET 6-10)
				i			
9	1021.20		1018.70				ODOT 2-2B MODIFIED (SEE DETAIL SHEET C-8)
			10.0	12	60	0.40	ODOT Z ZB MODITED (SEE BETTIE STEET O' O)
10	1022.75	1018.46					TYPE 3 MANHOLE (SEE SHEET C-10)
							THE GAMMANIGER (SEE STREET G. 10)
10	1022.75		1018.20				TYPE 3 MANHOLE (SEE SHEET C-10)
				15	76	0.40	
12	1022.00	1017.90					TYPE 3 MANHOLE (SEE SHEET C-10)
11	1021.40		1018.90				ODOT 2-2B MODIFIED (SEE DETAIL SHEET C-8)
				12	54	0.40)
12	1022.00	1018.68					TYPE 3 MANHOLE (SEE SHEET C-10)
							3
12	1022.00		1017.90				TYPE 3 MANHOLE (SEE SHEET C-10)
				18	18	0.76	
13	1019.67	1017.76	EX. 1017.76				TYPE 3 MANHOLE (SEE SHEET C-10)

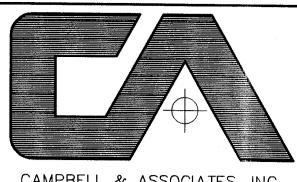

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8248 STORE NUMBER NWC LINCOLNWAY EAST AND WALES ROAD MASSILLON, OHIO (STARK COUNTY)

DEVELOPER:

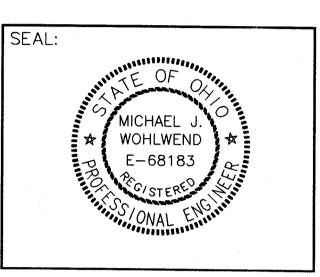DEAL TYPE

14600 DETROIT AVENUE LAKEWOOD, OHIO 44107 (216) 221-6600



REVISIONS:

1	
BID SET	2010-02-08
ADDENDUM_2	2010-02-26
BULLETIN B	2010-04-06

PLANNING MGR.

DRAWING BY: 2010-01-11

JOB NUMBER: 20090146

UTILITY PLAN

SHEET NUMBER:

IRRIGATION NOTE

IRRIGATION SYSTEM TO BE DESIGN/BUILD, BY OTHERS

2.) ALL STORM SEWER TO HAVE ODOT TYPE 1 BEDDING.

SANITARY SEWER NOTES

RIGHT OF WAY NOTES

UTILITIES NOTE:

I.) ALL STORM SEWER PIPES TO BE ITEM 603, CONDUIT TYPE B. BACKFILL UNDER PAVEMENT SHALL BE GRANULAR MATERIAL

ALL 6" SANITARY LATERAL SHALL BE LAID AT A MINIMUM GRADE OF 1.0%. SANITARY SEWERS WITHIN THE RIGHT-OF-WAY

ALL CONSTRUCTION WORK WITHIN RIGHT OF WAY REQUIRES INSPECTION FROM ENGINEERING DEPARTMENT (330-830-1722).

CONTRACTOR SHALL SCHEDULE A PRECONSTRUCTION MEETING WITH ENGINEERING DEPARTMENT PRIOR TO CONSTRUCTION.

THE EXISTING UNDERGROUND UTILITIES AS SHOWN ARE OBTAINED FROM

OBTAINED FROM THE RESPECTIVE UTILITY COMPANIES, WHERE PROVIDED. THESE UTILITIES, THEIR LOCATION AND THEIR ACTIVE OR INACTIVE STATUS, PROTECTION SERVICE (O.U.P.S.), PRIOR TO CONSTRUCTION.

LOCATION, SIZE, DEPTH AND STATUS OF USE ARE SHOWN AS ACCURATE AS POSSIBLE WITH THE AVAILABLE EXISTING DATA AS OF 11/23/09.

A COMBINATION OF FIELD LOCATION AND RECORD INFORMATION

PAYMENT FOR COMPACTED GRANULAR BACKFILL MATERIAL SHALL BE INCLUDED IN THE PRICE BID FOR ITEM 603.

3.) ALL STORM SEWER CONSTRUCTED UNDER THIS PLAN SHALL MEET THE REQUIREMENTS OF ODOT CMS ITEM 603.

1.) ALL SANITARY SEWERS CONSTRUCTED UNDER THIS PLAN SHALL MEET THE REQUIREMENTS OF CMS ITEM 603. 2.) THE MINIMUM REQUIREMENTS FOR SANITARY PIPE SHALL BE PVC PLASTIC SEWER PIPE, ASTM D-3034, SDR 35.


4.) ALL STORM SEWER SHALL BE HDPE (ODOT ITEM 707.33) UNLESS SPECIFICALLY NOTED.

6.) TOP ELEVATIONS FOR ODOT 3A CATCH BASINS ARE TOP/BACK OF CURB ELEVATION.

5.) ALL DOWN SPOUTS TO BE CONNECTED TO PROPOSED STORM SEWER.

SHALL MEET THE REQUIREMENTS OF THE CITY OF MASSILLON.

STORM SEWER NOTES

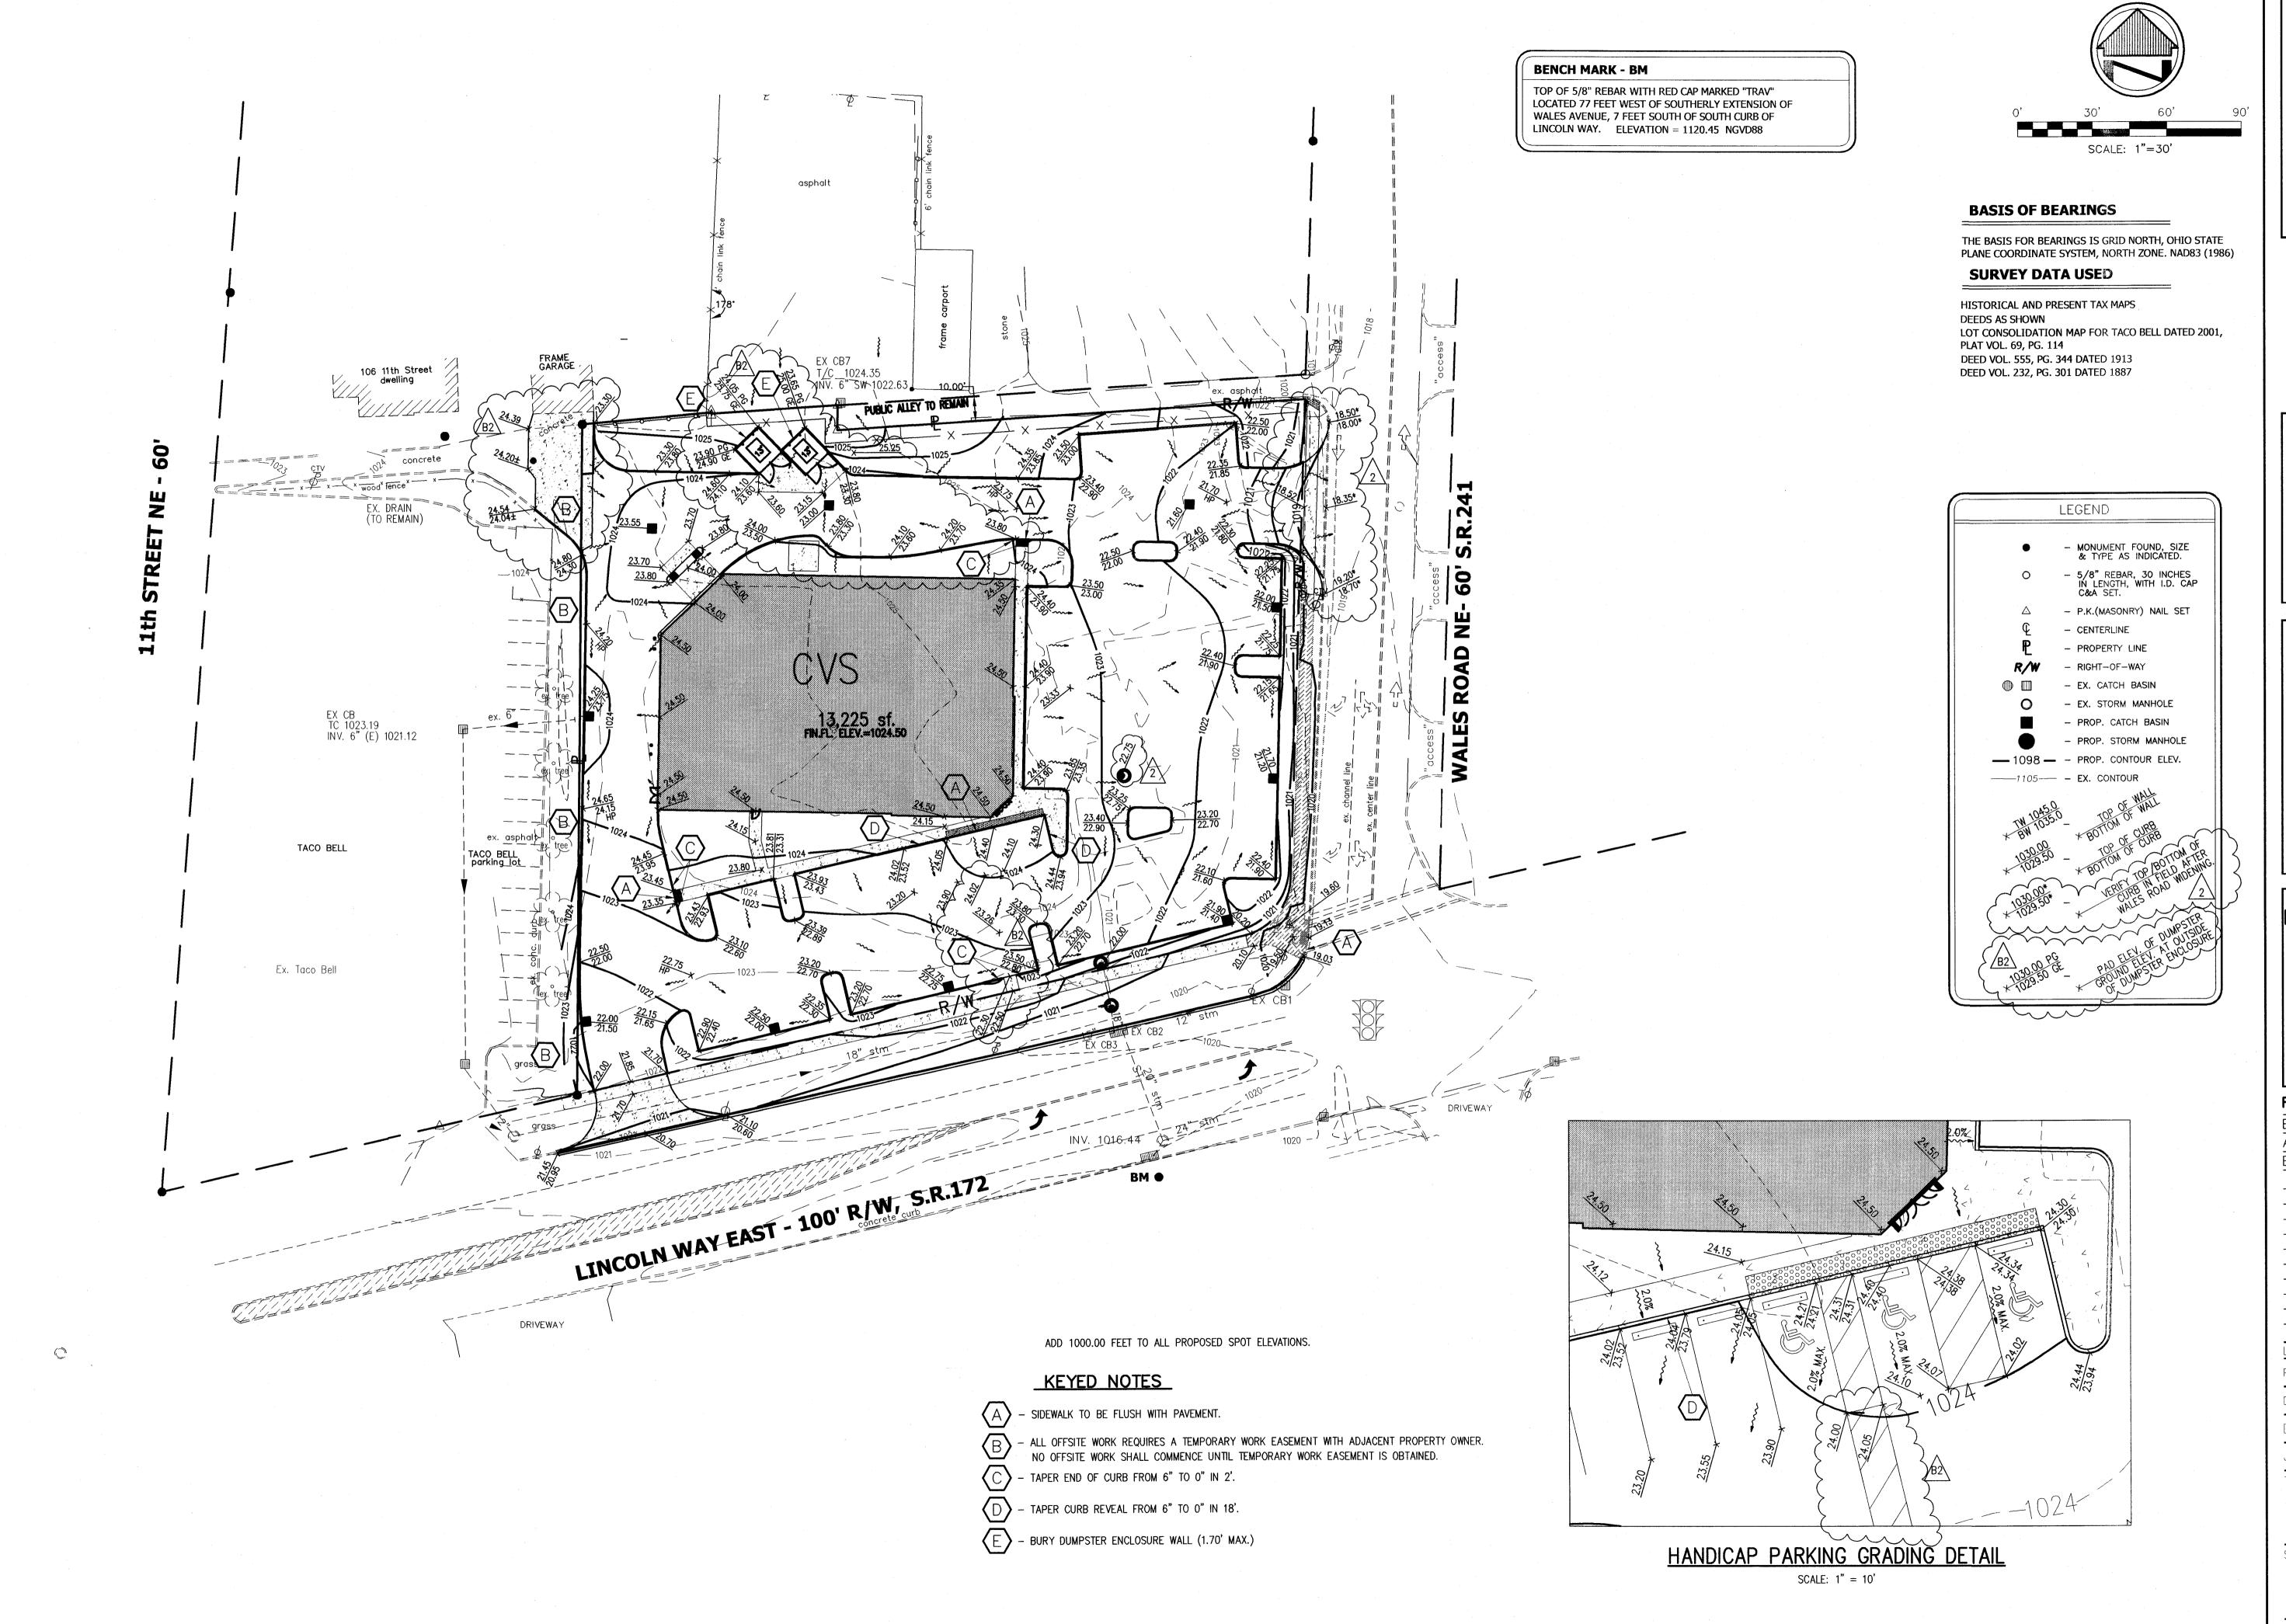




CAMPBELL & ASSOCIATES, INC.

Surveying Engineering

(330) 945-4117

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8248
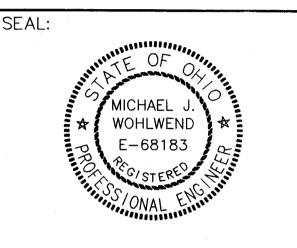
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REVISIONS:

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ADDENDUM_2	2010-02-26
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VOLIT COORD

LAYOUT COORD:

PLANNING MGR.

DRAWING BY: JJF


DATE: 2010-01-11

JOB NUMBER: 20090146

PAVING, GRADING DRAINAGE PLAN

SHEET NUMBER:

C-5

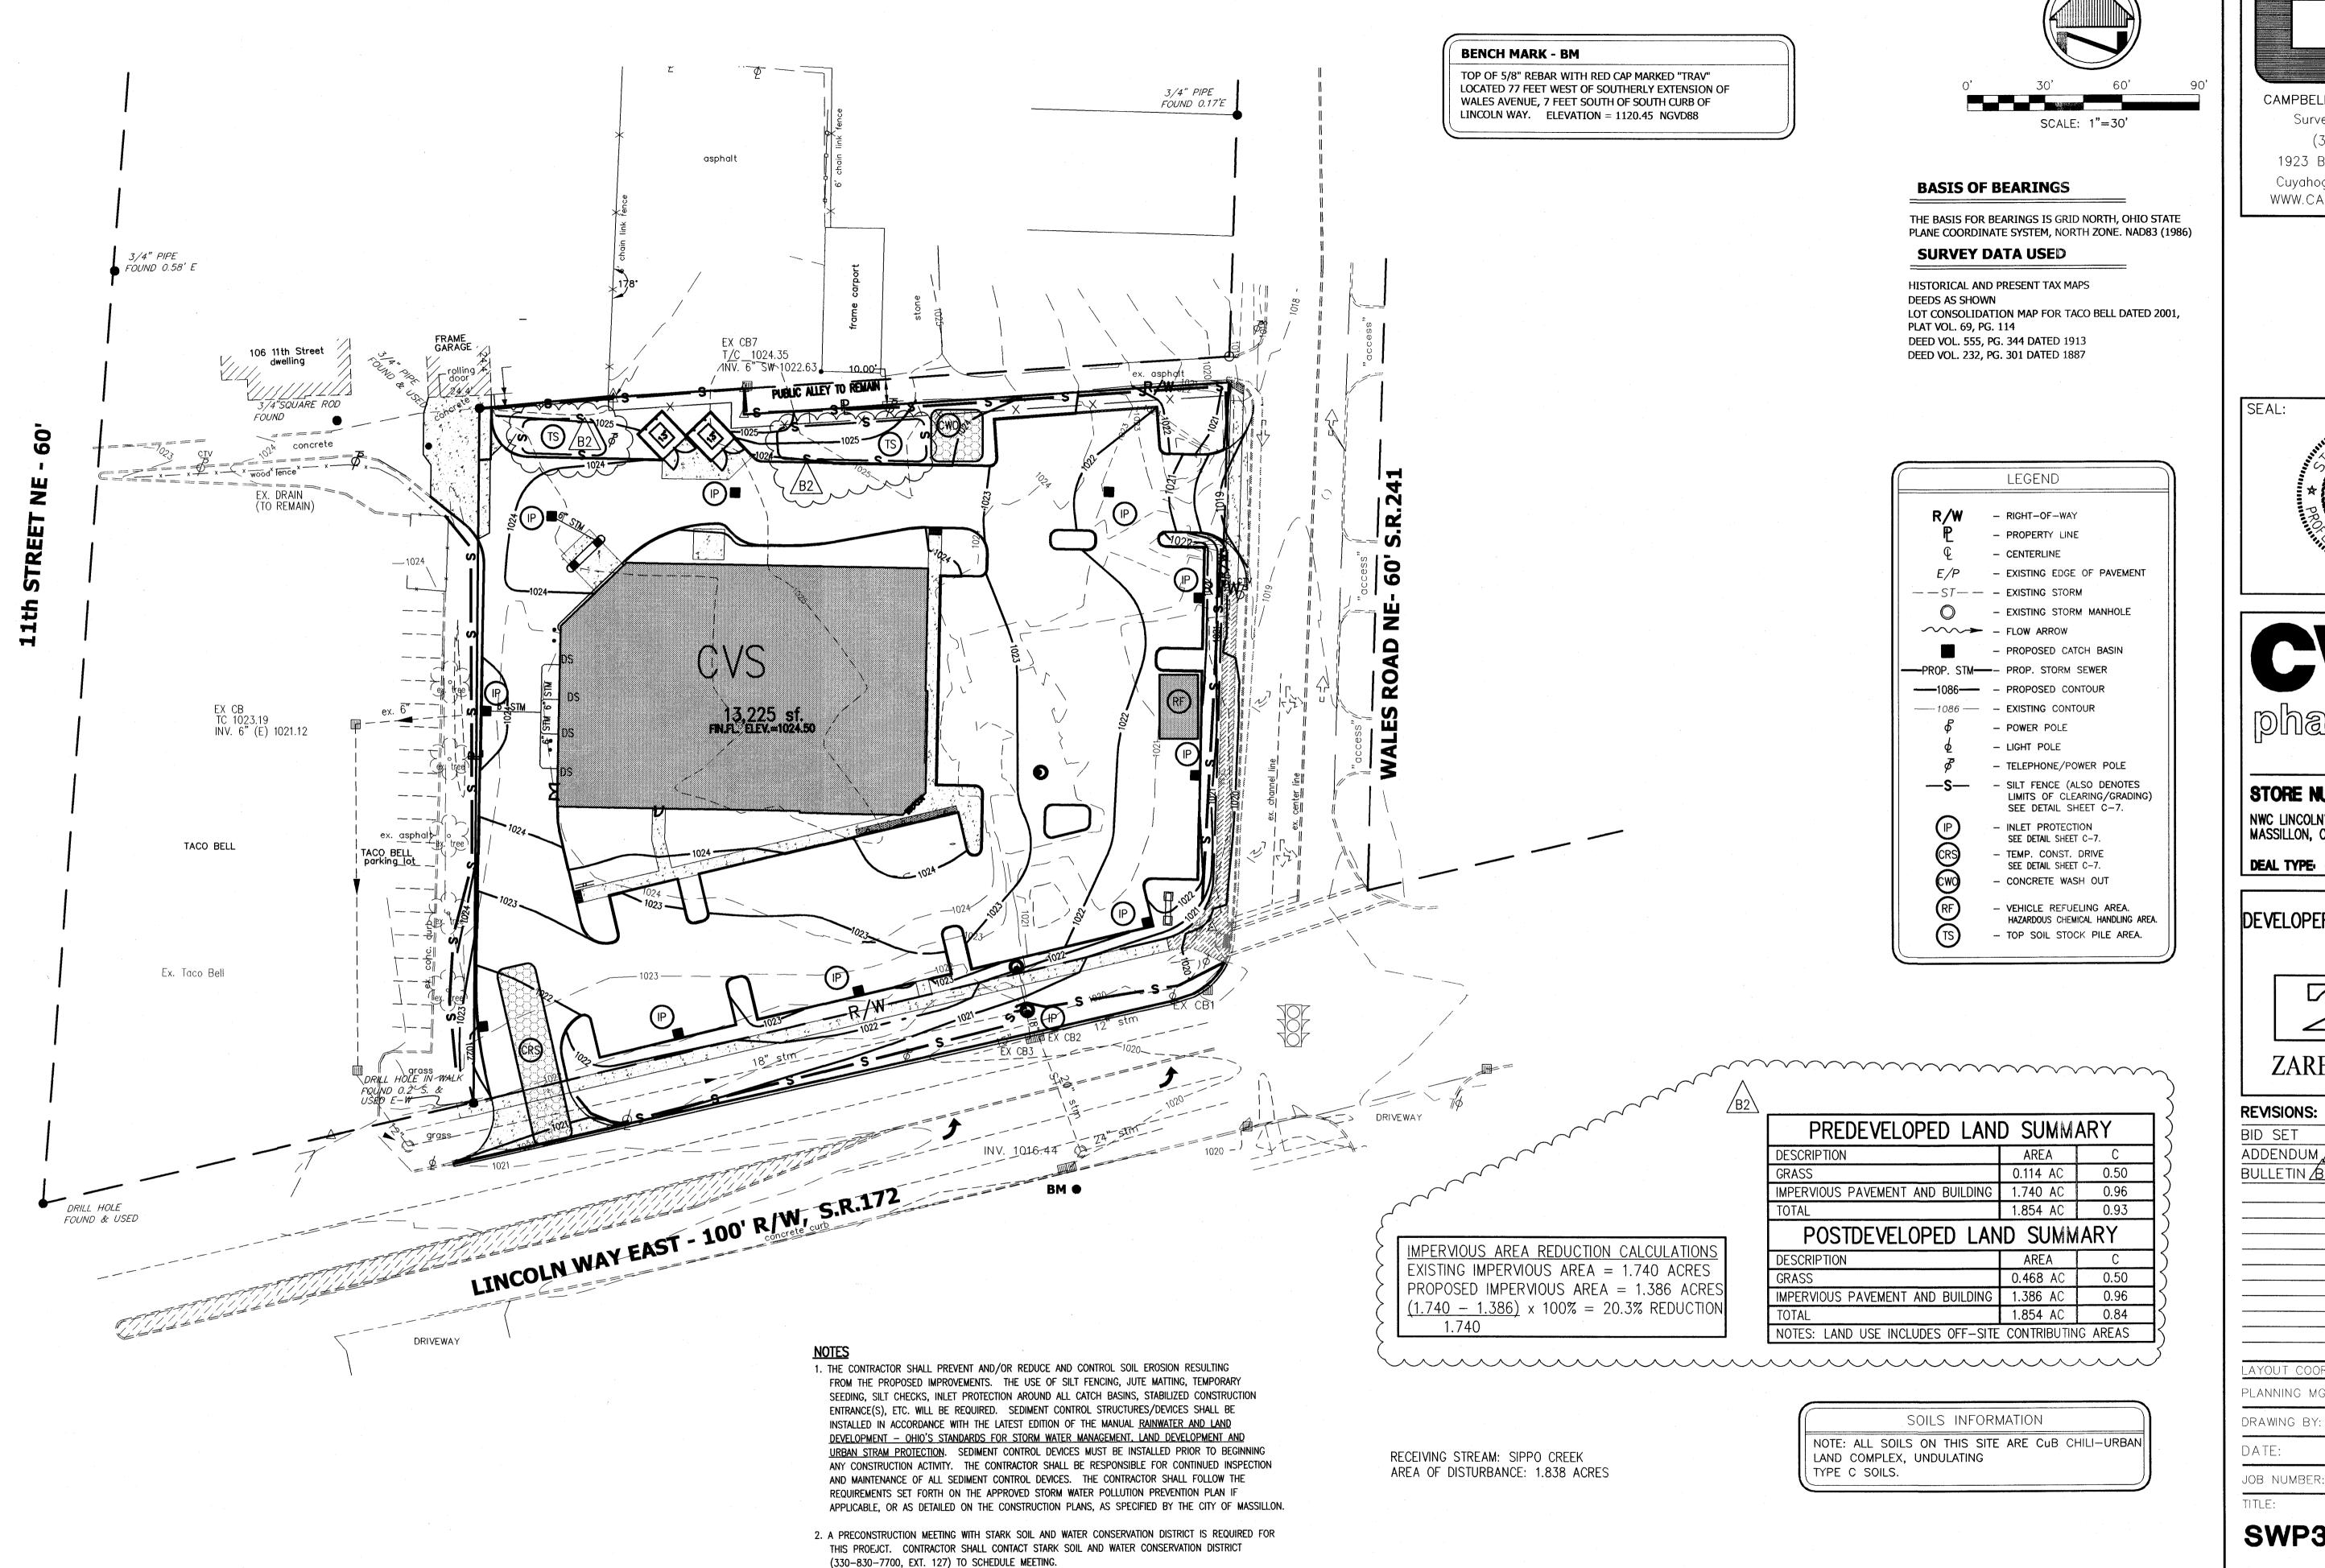

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CAMPBELL & ASSOCIATES, INC. Surveying Engineering (330) · 945-4117

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SEAL: WOHLWEND

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DEAL TYPE

DEVELOPER: 14600 DETROIT AVENUE LAKEWOOD, OHIO 44107 (216) 221-6600

ZAREMBA GROUP

REVISIONS:

BID SET 2010-02-08 2010-02-26 ADDENDUM /2 BULLETIN BZ 2010-04-06

LAYOUT COORD: PLANNING MGR.

DATE: 2010-01-11 JOB NUMBER: 20090146

SWP3 PLAN

SHEET NUMBER:

SOIL AMENDMENTS——APPLICATIONS OF TEMPORARY

VEGETATION SHALL ESTABLISH ADEQUATE STRANDS

ON THE SITE TO PREDICT THE NEED FOR LIME AND

SOIL AMMENDMENTS. SOIL TESTS SHOULD BE TAKEN

OF VEGETATION WHICH MAY REQUIRE THE USE OF

SEEDING METHOD--SEED SHALL BE APPLIED

CULTIPACKER SEEDER. OR HYDROSEEDER. WHEN

FEASIBLE. SEED THAT HAS BEEN BROADCAST SHALL

CULTIPACKER. IF HYDROSEEDING IS USED, THE SEED

BE COVERED BY RAKING OR DRAGGING AND THEN

LIGHTLY TAMPED INTO PLACE USING A ROLLER OR

AND FERTILIZER WILL BE MIXED ON-SITE AND THE

THE SEEDING SHALL BE DONE IMMEDIATELY AND

3. STRAW MULCH SHALL BE ANCHORED IMMEDIATELY

- MECHANICAL-A DISK, CRIMPER, OR SIMILAR

TYPE TOOL SHALL BE SET STRAIGHT TO PUNCH

OR ANCHOR THE MULCH MATERIAL INTO THE

SOIL. STRAW MECHANICALLY ANCHORED SHALL

NOT BE FINELY CHOPPED BUT, GENERALLY, BE

RECOMMENDATIONS. NETTING MAY BE NECESSARY

CONCENTRATION RUNOFF AND ON CRITICAL SLOPES.

AS RECOMMENDED BY THE MANUFACTURER OR AT

- ASPHALT EMULSION-ASPHALT SHALL BE APPLIED

- SYNTHETIC BINDERS-SYNTHETIC BINDERS SUCH AS

TERRA TACK OR EQUAL MAY BE USED AT RATES

- WOOD CELLULOSE FIBER-WOOD-CELLULOSE FIBER

BINDER SHALL BE APPUED AT A NET DRY WEIGHT

OF 750 LB./AC. THE WOOD-CELLULOSE FIBER

SHALL CONTAIN A MAXIMUM OF 50 LB./GAL.

SHALL BE MIXED WITH WATER AND THE MIXTURE

ACRYLIC DLR (AGRI-TAC), DCA-70, PETROSET.

RECOMMENDED BY THE MANUFACTURER.

- MULCH NETTINGS-NETTINGS SHALL BE USED

ACCORDING TO THE MANUFACTURER'S

TO MINIMIZE LOSS BY WIND OR WATER.

UNIFORMLY WITH A CYCLONE SEEDER, DRILL.

FERTILIZER.

WITHOUT INTERRUPTION.

ANCHORING METHODS:

LEFT LONGER THAN 6 IN.

THE RATE OF 160 GAL./AC.

1. STRUCTURAL EROSION AND SEDIMENT CONTROL PRACTICES SUCH AS DIVERSION AND SEDIMENT TRAPS SHALL BE INSTALLED AND STABILIZED WITH TEMPORARY SEEDING PRIOR TO GRADING THE REST OF THE CONSTRUCTION SITE.

2. TEMPORARY SEED SHALL BE APPLIED BETWEEN CONSTRUCTION OPERATIONS ON SOIL THAT WILL NOT BE GRADED OR REWORKED FOR 21 DAYS OR MORE. THESE IDLE AREAS SHOULD BE SEEDED AS SOON AS POSSIBLE AFTER GRADING OR SHALL BE SEEDED WITHIN 7 DAYS. SEVERAL APPLICATIONS OF TEMPORARY SEEDING ARE NECESSARY ON TYPICAL CONSTRUCTION PROJECTS.

3. THE SEEDBED SHOULD BE PULVERIZED AND LOOSE TO ENSURE THE SUCCESS OF ESTABLISHING VEGETATION. HOWEVER, TEMPORARY SEEDING SHALL NOT BE POSTPONED IF IDEAL SEEDBED PREPARATION IS NOT POSSIBLE

MULCHING TEMPORARY SEEDING

1. APPLICATIONS OF TEMPORARY SEEDING SHALL INCLUDE MULCH WHICH SHALL BE APPLIED DURING OR IMMEDIATELY AFTER SEEDING. SEEDINGS MADE DURING OPTIMUM SEEDING DATES AND WITH FAVORABLE SOIL CONDITIONS AND ON VERY FLAT AREAS MAY NOT NEED MULCH TO ACHIEVE ADEQUATE STABILIZATION.

2. MATERIALS

•

 STRAW-IF STRAW IS USED, IT SHALL BE UNROTTED SMALL-GRAIN STRAW APPLIED AT THE RATE OF 2 TONS/AC. OR 90LB./1000 SQ. FT. (TWO TO THREE BALES). THE MULCH SHALL BE SPREAD UNIFORMLY BY HAND OR MECHANICALLY SO THE SOIL SURFACE IS COVERED. FOR UNIFORM DISTRIBUTION OF HAND-SPREAD MULCH, DIVIDE AREA INTO APPROXIMATELY 1000 SQ.-FT. SECTIONS AND SPREAD TWO 45 LB. BALES OF STRAWN EACH

- HYDROSEEDERS-IF WOOD CELLULOSE FIBER IS USED, IT SHALL BE USED AT 2000 LB./AC. OR 46LB./1000 SQ. FT.

- OTHER-OTHER ACCEPTABLE MULCHES INCLUDE MULCH MATTINGS APPLIED ACCORDING TO MANUFACTURER'S RECOMMENDATIONS OR WOOD CHIPS APPLIED AT 6 TONS/AC.

NON-SEDIMENT POLLUTION CONTROL

1. CONTRACTOR SHALL FOLLOW PRACTICES IN CHAPTER 8 OF THE CURRENT RAINWATER AND LAND DEVELOPMENT MANUAL FOR NON-SEDIMENT POLLUTION CONTROL MEASURES (TOXIC AND HAZARDOUS MATERIALS). INCLUDING SPILL PREVENTION AND CLEANUP MEASURES FOR LARGE AND SMALL SPILLS.

SOLID, SANITARY, AND TOXIC WASTE MUST BE DISPOSED OF IN A PROPER MANNER IN ACCORDANCE WITH LOCAL, STATE, AND FEDERAL REGULATIONS. IT IS PROHIBITED TO BURN. BURY, OR POUR OUT ONTO THE GROUND OR INTO THE STORM SEWERS ANY SOLVENTS, PAINTS, STAINS, GASOLINE, DEISEL FUEL, USED MOTOR OIL, HYDRAULIC FLUID, AND ANTIFREEZE CEMENT CURING COMPOUNDS AND OTHER SUCH TOXIC OR HAZARDOUS WASTES. STORAGE TANKS SHALL BE LOCATED IN DIKED AREAS AWAY FROM ANY DRAINAGE CHANNELS. THE DIKED AREA SHALL HOLD A VOLUME EQUAL TO 110% OF THE LARGEST TANK.

2. CONSTRUCT CONCRETE WASH OUTS PER RAINWATER AND LAND DEVELOPMENT MANUAL.

CONTRACTOR TO COMPLY WITH THE RAINWATER AND LAND DEVELOPMENT MANUAL (2006 EDITION).

GENERAL SWPPP NOTE

1. THE CONTRACTOR SHALL PREVENT AND/OR REDUCE AND CONTROL SOIL EROSION RESULTING FROM THE PROPOSED IMPROVEMENTS. THE USE OF SILT FENCING, JUTE MATTING, TEMPORARY SEEDING, SILT CHECKS, INLET PROTECTION AROUND ALL CATCH BASINS, STABILIZED CONSTRUCTION ENTRANCE(S), ETC. WILL BE REQUIRED. SEDIMENT CONTROL STRUCTURES/DEVICES SHALL BE INSTALLED IN ACCORDANCE WITH THE LATEST EDITION OF THE MANUAL RAINWATER AND LAND <u>DEVELOPMENT - OHIO'S STANDARDS FOR STORM WATER MANAGEMENT, LAND DEVELOPMENT AND</u> URBAN STRAM PROTECTION. SEDIMENT CONTROL DEVICES MUST BE INSTALLED PRIOR TO BEGINNING ANY CONSTRUCTION ACTIVITY. THE CONTRACTOR SHALL BE RESPONSIBLE FOR CONTINUED INSPECTION AND MAINTENANCE OF ALL SEDIMENT CONTROL DEVICES. THE CONTRACTOR SHALL FOLLOW THE REQUIREMENTS SET FORTH ON THE APPROVED STORM WATER POLLUTION PREVENTION PLAN IF APPLICABLE, OR AS DETAILED ON THE CONSTRUCTION PLANS, AS SPECIFIED BY THE CITY OF MASSILLON.

2. A PRECONSTRUCTION MEETING WITH STARK SOIL AND WATER CONSERVATION DISTRICT IS REQUIRED FOR THIS PROEJCT. CONTRACTOR SHALL CONTACT STARK SOIL AND WATER CONSERVATION DISTRICT (330-830-7700, EXT. 127) TO SCHEDULE MEETING.

GENERAL NOTES

- SEDIMENT PONDS/TRAPS AND PERIMETER CONTROLS SHALL BE IMPLEMENTED AS A FIRST STEP OF GRADING WITHIN 7 DAYS FROM THE START OF GRUBBING AND SHALL CONTINUE TO FUNCTION UNTIL UPLAND AREAS HAVE BEEN STABILIZED.

GENERAL

- DISTURBED AREAS MORE THAN 50 FT FROM A STREAM WHICH WILL REMAIN UNWORKED FOR A PERIOD OF 21 DAYS OR MORE, SHALL BE STABILIZED WITH SEEDING AND MULCHING OR OTHER OTHER APPROPRIATE MEANS WITHIN 7 DAYS.

- DISTURBED AREAS WITHIN 50 FT OF A STREAM WHICH WILL REMAIN UNWORKED FOR A PERIOD OF 21 DAYS OR MORE, SHALL BE STABILIZED WITH SEEDING AND MULCHING OR OTHER OTHER APPROPRIATE MEANS WITHIN 2 DAYS.

 DITCHES WITH GRADES GREATER THAN 1.5% SHALL HAVE EROSION CONTROL BLANKETS/MATTING INSTALLED AS PART OF STABILIZATION MEASURES. - EROSION CONTROL BLANKETS SHALL BE USED TO AID IN VEGETATION ESTABLISHMENT ON ALL DISTURBED

SLOPES GREATER THAN 6%. - SLOPES OF THE ROADS AND DRIVES SHALL BE SEEDED AND BLANKETED IMMEDIATELY UPON THEIR

COMPLETION. - OFF-SITE VEHICLE TRACKING SEDIMENT SHALL BE MINIMIZED. CONSTRUCTION VEHICLES ARE LIMITED TO THE CONSTRUCTION ACCESS ROAD(S) NOTED ON PLAN.

- ALL EROSION AND SEDIMENTATION CONTROL PRACTICES MUST MEET THE STANDARDS AND SPECIFICATIONS OF THE OHIO'S RAINWATER AND LAND DEVELOPMENT MANUAL (2006 EDITION).

- OTHER EROSION AND SEDIMENT CONTROL ITEMS MAY BE NECESSARY DUE TO ENVIRONMENTAL CONDITIONS.

EROSION AND SEDIMENT CONTROL PRACTICES NOT ALREADY SPECIFIED ON THIS PLAN MAY BE NECESSARY DUE TO UNFORESEEN ENVIRONMENTAL CONDITIONS AND/OR CHANGES IN DRAINAGE PATTERN CAUSED BY EARTH-MOVING ACTIVITY.

- A FULL LOT SEEDING AND MULCHING SHALL BE APPLIED TO ALL BARE AREAS IMMEDIATELY AFTER THE CONSTRUCTION OF THE STREETS ARE COMPLETED.

- NOTICE OF INTENT (NOI) MUST BE SUBMITTED TO OHIO EPA FOR NPDES PERMIT 45 DAYS PRIOR TO THE START OF CLEARING AND OR GRADING. CONSTRUCTION MUST COMPLY WITH ALL LOCAL EROSION AND SEDIMENT CONTROL REGULATIONS NO SOLID OR LIQUID WASTE SHOULD BE DISCHARGED

STORM WATER RUNOFF. - SWPPP MUST SHOW COMPLIANCE WITH LOCAL WASTE DISPOSAL, SANITARY, AND HEALTH REGULATIONS. - IF MUD. SOIL, OR OTHER DEBRIS IS DEPOSITED ON ADJACENT STREETS, ROADS OR OTHER PROPERTY. THE CONTRACTOR SHALL BE RESPONSIBLE FOR

THE REMOVAL OF SUCH AS DIRECTED BY THE CITY

OR ITS ENGINEER AT THE END OF EACH WORK DAY.

- DISTURBED AREAS ARE NOT CONSIDERED STABILIZED UNTIL VEGETATIVE GROWTH IS AT LEAST 70% OR EQUIVALENT.

- TRENCH DEWATERING MUST PASS THROUGH A FILTER

MAINTENANCE AND INSPECTION PERMANENT RECORDS OF MAINTENANCE AND INSPECTION MUST BE MAINTAINED A MINIMUM OF ONCE EVERY SEVEN DAYS AND AFTER STORM EVENTS GREATER THAN 0.5 INCH IN A 24 HOUR PERIOD. NAME OF INSPECTOR, MAJOR

OBSERVATIONS, DATE OF INSPECTION, CERTIFICATION OF COMPLIANCE, CORRECTIVE MEASURES TAKEN. RECORDS MUST BE MAINTAINED FOR 2 YEARS AFTER NOTICE OF INTENT PER OHIO EPA NPDES PERMIT. REPAIRS

ANY EROSION CONTROL MEASURES, STRUCTURES, DEVICES, OR RELATED ITEMS IN NEED OF REPAIR WILL BE MADE WITHIN FIFTEEN DAYS.

WINTERIZATION

ANY DISTURBED AREA THAT IS NOT GOING TO BE WORKED FOR 21 DAYS OR MORE MUST BE SEEDED AND MULCHED BY NOVEMBER 1 OR MUST HAVE DORMANT SEEDING OR MULCH COVER APPLIED BETWEEN NOVEMBER 1 AND MARCH 1.

MULCHING

1. MULCH MATERIAL SHALL BE APPLIED IMMEDIATELY AFTER SEEDING. SEEDINGS MADE DURING OPTIMUM SEEDING DATES AND WITH FAVORABLE SOIL CONDITIONS AND ON VERY FLAT AREAS MAY NOT NEED MULCH TO ACHIEVE ADEQUATE STABILIZATION. DORMANT SEEDING SHALL BE MULCHED.

2. MATERIALS

- STRAW - IF STRAW IS TO BE USED IT SHALL BE UNROTTED SMALL-GRAIN STRAW APPLIED AT THE RATE OF 2 TONS/AC. OR 90 LB./1000 SQ.FT. (TWO TO THREE BALES). THE MULCH SHALL BE SPREAD UNIFORMLY BY HAND OR MECHANICALLY SO THE SOIL SURFACE IS COVERED. FOR UNIFORM DISTRIBUTION OF HAND-SPREAD MULCH, DIVIDE AREA INTO APPROXIMATELY 1000 SQ.FT. SECTIONS AND SPREAD TWO 45 LB. BALES OF STRAW IN IN EACH SECTION.

- HYDROSEEDERS - IF WOOD CELLULOSE FIBER IS USED, IT SHALL BE USED AT 2000 LB./AC. OR 46 LB./1000 SQ.FT.

- OTHER - OTHER ACCEPTABLE MULCHES INCLUDE MULCH MATTINGS APPLIED ACCORDING TO MANUFACTURER'S RECOMMENDATIONS OR WOOD CHIPS APPLIED AT 6 TONS/AC.

STRAW MULCH ANCHORING METHODS STRAW MULCH SHALL BE ANCHORED IMMEDIATELY

TO MINIMIZE LOSS BY WIND OR WATER. - MECHANICAL — A DISK, CRIMPER, OR SIMILAR TYPE TOOL SHALL BE SET STRAIGHT TO PUNCH OR ANCHOR THE MULCH MATERIAL INTO THE SOIL. STRAW MECHANICALLY ANCHORED SHALL NOT BE FINELY CHOPPED BUT, GENERALLY, BE LEFT LONGER THAN 6 IN.

- MULCH NETTINGS - NETTINGS SHALL BE USED ACCORDING TO THE MANUFACTURER'S RECOMMENDATIONS NETTING MAY BE NECESSARY TO HOLD MULCH IN PLACE IN AREAS OF CONCENTRATED RUNOFF AND ON CRITICAL SLOPES.

- ASPHALT EMULSION — ASPHALT SHALL BE APPLIED AS RECOMMENDED BY THE MANUFACTURER OR AT THE RATE OF 160 GAL./AC.

 SYNTHETIC BINDERS — SYNTHETIC BINDERS SUCH AS ACRYLIC DLR (AGRI-TAC), DCA-70, PETROSET TERRA TACK, OR EQUAL MAY BE USED AT RATES RECOMMENDED BY THE MANUFACTURER.

 WOOD CELLLULOSE FIBER - WOOD CELLULOSE FIBER SHALL BE APPLIED AT A NET DRY WEIGHT OF 750 LB./AC. THE WOOD CELLULOSE FIBER SHALL BE MIXED WITH WATER AND THE MIXTURE SHALL CONTAIN A MAXIMUM OF 50 LB./100 GAL. OF WOOD CELLULOSE FIBER.

IRRIGATION


1. PERMANENT SEEDING SHALL INCLUDE IRRIGATION TO ESTABLISH VEGETATION DURING DRY OR HOT WEATHER OR ON ADVERSE SITE CONDITIONS AS NEEDED FOR ADEQUATE MOISTURE FOR SEED GERMINATION AND PLANT GROWTH.

2. EXCESSIVE IRRIGATION RATES SHALL BE AVOIDED AND IRRIGATION MONITORED TO PREVENT EROSION AND DAMAGE FROM RUNOFF.

PERMANENT SEEDING

1. DISTURBED AREAS REMAINING DORMANT FOR OVER A YEAR AND AT FINAL GRADE SHALL HAVE THE PERMANENT LANDSCAPING COVER INSTALLED PER LANDSCAPING PLAN.

2. DISTURBED AREAS WITHIN 50 FEET OF A STREAM MUST HAVE A PERMANENT COVER APPLIED WITHIN 2 DAYS OF REACHING FINAL GRADE.

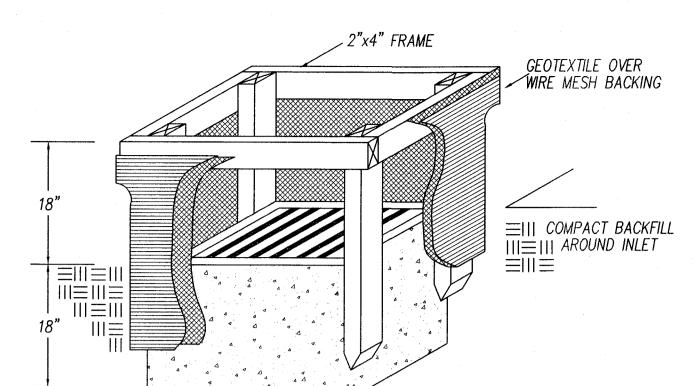

1. INLET PROTECTION SHALL BE CONSTRUCTED EITHER BEFORE UPSLOPE LAND DISTURBANCE OR BEFORE THE STORM DRAIN BECOMES OPERATIONAL.

2. THE EARTH AROUND THE INLET SHALL BE EXCAVATED COMPLETELY TO A DEPTH AT LEAST 18

. THE WOODEN FRAME SHALL BE CONSTRUCTED OF 2 BY 4 IN. CONSTRUCTION-GRADE LUMBER. THE 2 BY 4 IN. POSTS SHALL BE DRIVEN 2 FT. INTO THE GROUND AT FOUR CORNERS OF THE INLET AND THE TOP PORTION OF THE 2 BY 4 IN. FRAMED PORTION OF 2 BY 4 IN. FRAME ASSEMBLED USING THE OVERLAP JOINT SHOWN. THE TOP OF THE FRAME SHALL BE AT LEAST 6 IN. BELOW ADJACENT ROADS II PONDED WATER WOULD POSE A SAFETY

HAZARD TO TRAFFIC.

WIRE MESH SHALL BE OF SUFFICIENT STRENGTH TO SUPPORT FABRIC WITH WATER FULLY IMPOUNDED AGAINST IT. IT SHALL BE STRETCHED TIGHTLY AROUND THE FRAME AND FASTENED SECURELY TO THE FRAME.

5. GEOTEXTILE SHALL HAVE AN EQUIVALENT OPENING SIZE OF 20-40 SIEVE AND BE RESILIENT TO SUNLIGHT. IT SHALL BE STRETCHED TIGHTLY AROUND THE FRAME AND FASTENED SECURELY. IT SHALL EXTEND FROM THE TOP OF THE FRAME TO 18 IN. BELOW THE INLET NOTCH ELEVATION. THE GEOTEXTILE SHALL OVERLAP ACROSS ONE SIDE OF THE INLET SO THE ENDS OF THE CLOTH ARE NOT FASTENED TO THE SAME POST.

6. BACKFILL SHALL BE PLACED AROUND THE INLET IN COMPACTED 6 IN. LAYERS UNTIL THE EARTH IS EVEN WITH NOTCH ELEVATION ON ENDS AND TOP ELEVATION ON SIDES.

7. A COMPACTED EARTH DIKE OR A CHECK DAM SHALL BE CONSTRUCTED IN THE DITCH LINE BELOW THE INLET IF THE INLET IS NOT IN A DEPRESSION AND IF RUNOFF BYPASSING THE INLET WILL NOT FLOW TO A SETTLING POND. THE TOP OF THE EARTH DIKES SHALL BE AT LEAST 6 IN. HIGHER THAN THE TOP OF THE FRAME.

INLET PROTECTION

N.T.S.



SEQUENCE OF CONSTRUCTION

1. INSTALL SILT FENCE & CATCH BASIN PROTECTION.

2. DEMOLISH EXISTING BUILDINGS AND PAVEMENT.

3. BEGIN ROUGH GRADING.


4. CONSTRUCT STORM SEWER AND RESPECTIVE INLET PROTECTION & INSTALL PROPOSED UTILITIES.

5. BEGIN CONSTRUCTION OF BUILDING.

6. FINISH REMAINING SITE WORK AND STABILIZE THE SITE.

7. ONCE SITE IS STABILIZED, REMOVE REMAINING EROSION AND SEDIMENT CONTROLS.

TENTATIVE SCHEDULE OF MAJOR CONSTRUCTION OPERATIONS 2010												
	J	F	M	Α	M	J	7	Α	S	0	N	D
CLEARING						Χ	Χ					
SILT FENCE						Χ	Χ	X	Χ	Χ	Х	
SEDIMENTATION BASINS												
STRAW BALE BARRIERS												
DRAINAGE-WAY ROUTING						Χ	Χ	Χ				
INLET PROTECTION						Х	Χ	X	X	Χ	Χ	
DITCH PROTECTION												
MULCHING						Χ	Χ	Χ	X	Χ	Χ	
TEMP. SEEDING & MULCHING						Χ	Χ	X	X	X	Χ	
PERM. SEEDING & MULCHING						Χ	Х				Χ	
GRADING						Χ	Χ	Χ	X	Χ	X.	

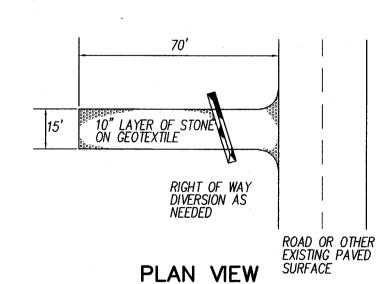

18" OR SUFFICIENT TO DIVERT RUNOFF PROFILE

N.T.S.

TEMPORARY CONSTRUCTION DRIVE NOTES:

1. STONE SHALL BE NO. 2 STONE OR RECYCLED CONCRETE.


2. LENGTH— THE CONSTRUCTION ENTRANCE SHALL BE AS LONG AS REQUIRED TO STABILIZE HIGH TRAFFIC AREAS BUT NOT LESS THAN 70 FEET. 3. THICKNESS- THE STONE LAYER SHALL BE AT LEAST 10 INCHES THICK.

4. WIDTH— THE ENTRANCE SHALL BE AT LEAST 15 FEET WIDE. 5. BEDDING- A GEOTEXTILE SHALL BE PLACED OVER THE ENTIRE AREA PRIOR TO PLACING OF STONE.

IT SHALL HAVE A GRAB TENSILE STRENGTH OF AT LEAST 200 LBS. AND A MULLEN BURST STRENGTH OF AT LEAST 190 LBS. 6. CULVERT— A PIPE OR CULVERT SHALL BE CONSTRUCTED UNDER THE ENTRANCE IF NEEDED TO PREVENT SURFACE WATER FLOWING ACROSS THE ENTRANCE FROM BEING DIRECTED OUT ONTO PAVED SURFACES.


7. MAINTENANCE - DRIVE SHALL BE TOP DRESSED WITH CLEAN STONE WHEN DIRECTED BY THE CITY.

TEMPORARY CONSTRUCTION DRIVE

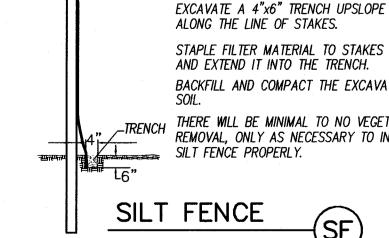

SET THE STAKES.

BACKFILL AND COMPACT THE EXCAVATED THERE WILL BE MINIMAL TO NO VEGETATION REMOVAL. ONLY AS NECESSARY TO INSTALL

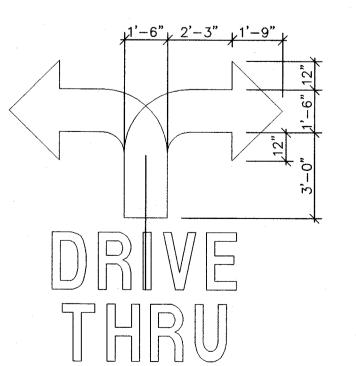


1. PAINT COLOR TO BE "YELLOW" FOR ARROW AND LETTERS. "DRIVE-THRU" LETTERS TO BE ELONGATED HELEVETICA MEDIUM -4" WIDE STROKES. 2. PAINT 2" BLACK OUTLINE AROUND ARROW AND LETTERS FOR PROJECTS WITH CONCRETE PARKING LOTS.

PAVEMENT PAINTING

N.T.S.

CAMPBELL & ASSOCIATES, INC Surveying Engineering $(330) \cdot 945 - 4117$ 1923 Bailey Road Suite A Cuyahoga Falls, Ohio 44221 WWW.CAMPBELLSURVEY.COM

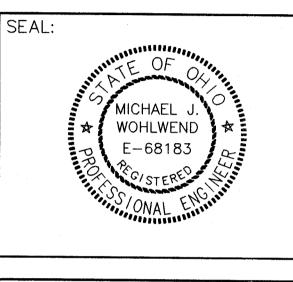



STORE NUMBER

8248 NWC LINCOLNWAY EAST AND WALES ROAD MASSILLON, OHIO (STARK COUNTY)

DEAL TYPE

14600 DETROIT AVENUE **DEVELOPER:** LAKEWOOD, OHIO 44107 (216) 221-6600



REVISIONS: BID SET 2010-02-08

LAYOUT COORD PLANNING MGR. DRAWING BY:

DATE: 2010 - 01 - 11JOB NUMBER: 20090146

SWP3 DETAILS

SHEET NUMBER:

LOCAL GOVERNMENT REQUIREMENTS TOGETHER WITH THE LATEST EDITION OF THE STATE OF OHIO, DEPT. OF TRANSPORTATION CONSTRUCTION AND MATERIAL SPECIFICATIONS (CMS) SHALL GOVERN ALL CONSTRUCTION ITEMS THAT ARE A PART OF THIS PLAN, UNLESS OTHERWISE NOTED. IF THÈRE ARE ANY DISCREPANCIES, THE CITY REQUIREMENTS SHALL GOVERN. ALL FIELD TESTING SHALL BE THE RESPONSIBILITY OF THE CONTRACTOR (MATERIAL COMPOSITION, MATERIAL COMPACTION, CONCRETE TESTING, ETC.).

2. ANY MODIFICATION TO THE SPECIFICATIONS OR CHANGES TO THE WORK AS SHOWN ON THESE DRAWINGS MUST HAVE PRIOR WRITTEN APPROVAL OF THE CITY ENGINEER. 3. THE CONTRACTOR AND SUBCONTRACTOR SHALL BE SOLELY RESPONSIBLE FOR COMPLYING WITH ALL FEDERAL, STATE, AND LOCAL SAFETY REQUIREMENTS, TOGETHER WITH EXERCISING PRECAUTIONS AT ALL TIMES FOR THE PROTECTION OF PERSONS (INCLUDING EMPLOYEES) AND PROPERTY. IT IS ALSO THE SOLE RESPONSIBILITY OF THE CONTRACTOR AND

4. THE CONTRACTOR SHALL NOTIFY THE CITY AT LEAST TWO (2) WORKING DAYS PRIOR TO COMMENCING CONSTRUCTION. 5. THE CONTRACTOR SHALL OBTAIN ALL NECESSARY PERMITS, PRIOR TO CONSTRUCTION.

SUBCONTRÀCTOR TO INITIATE, MAINTAIN AND SUPERVISE ALL SAFETY REQUIREMENTS, PRECAUTIONS, AND PROGRAMS IN

6. EXISTING UTILITIES SHOWN ARE FROM BEST AVAILABLE RECORDS AND FIELD INVESTIGATION, AND ARE NOT NECESSARILY COMPLETE OR EXACT. THE CONTRACTOR IS RESPONSIBLE FOR THE INVESTIGATION, LOCATION, SUPPORT, PROTECTION, AND RESTORATION OF ALL EXISTING UTILITIES AND APPURTENANCES WHETHER SHOWN ON THESE PLANS OR NOT. THE CONTRACTOR SHALL EXPOSE ALL UTILITIES OR STRUCTURES PRIOR TO CONSTRUCTION TO VERIFY THE VERTICAL AND HORIZONTAL EFFECT ON THE PROPOSED CONSTRUCTION, AND SHALL MAKE ADJUSTMENTS IN ELEVATIONS TO PROVIDE SUFFICIENT CLEARANCE BETWEEN THE PROPOSED AND EXISTING UTILITIES. THE CONTRACTOR SHALL CALL THE OHIO UTILITIES PROTECTION SERVICE (1-800-362-2764) THREE WORKING DAYS PRIOR TO WORK

7. ANY PROPERTY CORNER PINS OR PERMANENT SURVEY MARKINGS DISTURBED DURING CONSTRUCTION SHALL BE RESET BY A REGISTERED SURVEYOR AT THE CONTRACTOR'S EXPENSE. 8. THE TRACKING OR SPILLAGE OF MUD, DIRT, OR DEBRIS UPON STREETS IS PROHIBITED AND ANY SUCH OCCURRENCE SHALL BE CLEANED UP IMMEDIATELY BY THE CONTRACTOR. IF THE CONTRACTOR FAILS TO KEEP THE WORK AREA CLEAN OF DEBRIS, OR FAILS TO CLEAN MUD OR DIRT OFF OF STREETS, THE CITY MAY TAKE ACTION AND ASSESS THE DEVELOPER

9. NO NON-RUBBER TIRE VEHICLE SHALL BE MOVED ON STREETS; EXCEPTIONS MAY BE GRANTED WHERE SHORT DISTANCES AND SPECIAL CIRCUMSTANCES ARE INVOLVED. GRANTING OF EXCEPTIONS MUST BE IN WRITING AND ANY RESULTING DAMAGE MUST BE REPAIRED TO THE SATISFACTION OF THE CITY ENGINEER.

10. THE CONTRACTOR SHALL BE RESPONSIBLE FOR MAINTAINING MAIL SERVICE IN THE CONSTRUCTION AREA. 11. ALL ITEMS OF WORK CALLED FOR ON THE PLANS FOR WHICH NO SPECIFIC METHOD OF PAYMENT IS PROVIDED SHALL BE PERFORMED BY THE CONTRACTOR AND THE COST OF SAME SHALL BE INCLUDED IN THE PRICE BID FOR THE VARIOUS

12. THE CONTRACTOR SHALL EXERCISE EXTREME CAUTION WHEN EXCAVATING IN THE VICINITY OF EXISTING TREES TO REMAIN, TAKING ALL MEASURES POSSIBLE TO PROTECT AND PRESERVE THEM. THE CONTRACTOR SHALL BE GOVERNED BY THE

PROVISIONS OF HIS CONTRACT WITH THE OWNER. 13. ALL FIELD TILE BROKEN DURING EXCAVATION SHALL BE REPLACED TO ITS ORIGINAL CONDITION OR CONNECTED TO THE STORM SEWER SYSTEM AS DIRECTED BY THE CITY ENGINEER. 14 APPROVAL OF THESE PLANS IS CONTINGENT ON ALL EASEMENTS REQUIRED FOR THE CONSTRUCTION OF THE WORK REING SECURED AND SUBMITTED TO THE CITY FOR RECORDING PRIOR TO COMMENCEMENT OF THE WORK, AND NO WORK

WHICH REQUIRES AN EASEMENT WILL BE ALLOWED TO PROCEED UNTIL THIS HAS BEEN DONE. 15. ALL TRAFFIC CONTROL DEVICES SHALL BE FURNISHED, ERECTED, MAINTAINED, AND REMOVED BY THE CONTRACTOR IN ACCORDANCE WITH THE OHIO MANUAL OF UNIFORM TRAFFIC CONTROL DEVICES PART 7 CONSTRUCTION AND MAINTENANCE OPERATIONS, COPIES OF WHICH ARE AVAILABLE FROM THE OHIO DEPARTMENT OF TRANSPORTATION, BUREAU OF TRAFFIC, 25 SOUTH FRONT STREET, COLUMBUS, OHIO 43215.

16. STEADY-BURNING, TYPE "C" LIGHTS SHALL BE REQUIRED ON ALL BARRICADES DRUMS AND SIMILAR TRAFFIC DEVICES IN USE AT NIGHT. CONES ARE NOT PERMITTED TO BE USED FOR NIGHT WORK.

17. ALL TRENCHES SHALL BE BACKFILLED OR SECURELY PLATED DURING NON WORKING HOURS. 18. ACCESS TO ALL ADJOINING PROPERTIES SHALL BE MAINTAINED AT ALL TIMES

19. ALL AREAS WITHIN THE PUBLIC RIGHT-OF-WAY THAT ARE DISTURBED BY THIS PROJECT SHALL BE RESTORED TO ORIGINAL OR BETTER CONDITION, PER CMS ITEM 659 (SEEDING AND MULCHING) OR OTHER APPLICABLE SPECIFICATIONS.

20. AT ALL UTILITY CROSSINGS WHERE THE EXISTING UTILITY IS EXPOSED IN THE TRENCH, THE BACKFILL SHALL CONSIST OF COMPACTED GRANULAR MATERIAL IN ACCORDANCE WITH CMS ITEM 603 BETWEEN THE DEEPER AND SHALLOWER PIPE. WHERE PROPOSED UTILITIES OR SERVICES CROSS PROPOSED OR EXISTING PAVEMENT AREAS, BACKFILL SHALL BE COMPACTED GRANULAR MATERIAL IN ACCORDANCE WITH CMS ITEM 603 EXTENDING AT LEAST 3 FEET BEYOND THE BACK OF CURB OR EDGE OF PAVEMENT. COST IS TO BE INCLUDED IN THE PRICE BID FOR RELATED PIPE.

21. IN THE EVENT EXCAVATION FOR THE STREET IS FROM 0" TO 6" BELOW THAT CALLED FOR ON THE PLANS, THE CONTRACTOR SHALL REPLACE THIS EXCESS EXCAVATED MATERIAL WITH ITEM 304 AGGREGATE, AND SHALL BE PAID FOR BY

22. CURB INLETS, MANHOLES, AND CATCH BASINS SHALL BE CHANNELED AS DIRECTED. 23. IT SHALL BE THE RESPONSIBILITY OF THE CONTRACTOR TO ADEQUATELY BARRICADE THE STREET IN THE VICINITY OF ALL EXPANSION JOINTS UNTIL SUCH TIME AS THE STREET IS OPEN TO TRAFFIC.

24. WHERE NECESSARY TO DISTURB PAVEMENTS OR DRIVES, THE PAVEMENT SHALL BE SAW CUT IN NEAT, STRAIGHT LINES. THE DEPTH OF SAW CUT SHALL BE AT LEAST 2 INCHES. 25. THE CITY ENGINEER WILL NOT BE RESPONSIBLE FOR MEANS, METHODS, PROCEDURES, TECHNIQUES, OR CONSEQUENCES


OF CONSTRUCTION THE CITY ENGINEER WILL NOT BE RESPONSIBLE FOR SAFETY ON THE JOB SITE, OR FOR FAILURE BY THE CONTRACTOR TO PERFORM WORK ACCORDING TO CONTRACT DOCUMENTS. 26. THE CONTRACTOR SHALL RESTRICT CONSTRUCTION ACTIVITY TO PUBLIC RIGHT-OF-WAY AND AREAS DEFINED AS PERMANENT AND/OR TEMPORARY CONSTRUCTION EASEMENTS.


27. THE CONTRACTOR SHALL RESTORE ALL DISTURBED AREAS TO EQUAL OR BETTER CONDITION THAT EXISTED BEFORE CONSTRUCTION, DRAINAGE DITCHES OR WATER COURSES THAT ARE DISTURBED BY CONSTRUCTION SHALL BE RESTORED TO THE GRADES AND CROSS SECTIONS THAT EXISTED BEFORE CONSTRUCTION.

OR ALL SIGNS LANDSCAPING STRUCTURES. OR OTHER APPURTENANCES DISTURBED OR DAMAGED DURING CONSTRUCTION SHALL BE REPLACED OR REPAIRED TO THE SATISFACTION OF THE CITY ENGINEER. THE COST OF SUCH WORK SHALL BE

29. PERMITS TO CONSTRUCT IN THE RIGHT-OF-WAY OF EXISTING STREETS MUST BE OBTAINED FROM THE CITY BEFORE COMMENCING CONSTRUCTION. WHEN OPEN-CUTTING OF EXISTING PAVEMENT IS PERMITTED, CONTROLLED DENSITY BACKFILL MAY BE USED IN PLACE OF COMPACTED GRANULAR BACKFILL. ASPHALT SURFACES SHALL BE HEAT WELDED. 30. WHEN UNKNOWN OR INCORRECTLY LOCATED UNDERGROUND UTILITIES ARE ENCOUNTERED DURING CONSTRUCTION, THE CONTRACTOR SHALL IMMEDIATELY NOTIFY THE OWNER AND THE CITY ENGINEER. 31. BEFORE RELOCATING ANY MAILBOXES, THE CONTRACTOR SHALL CONTACT THE U.S. POSTAL SERVICE AND RELOCATE MAILBOXES ACCORDING TO THE REQUIREMENTS OF THE POSTAL SERVICE.


32. ALL BENCHMARKS ARE BASED ON UNITED STATES GEOLOGICAL SURVEY (USGS) DATUM.

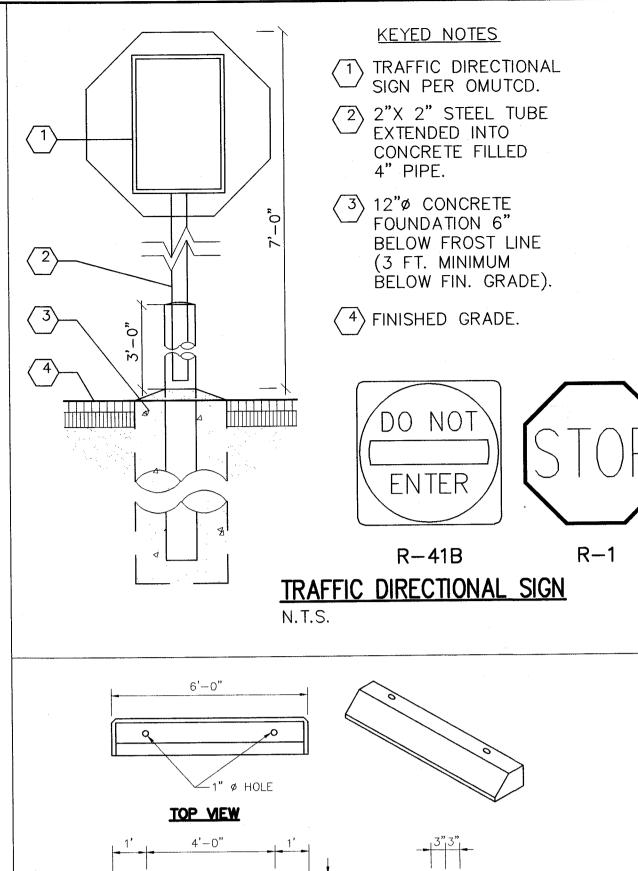

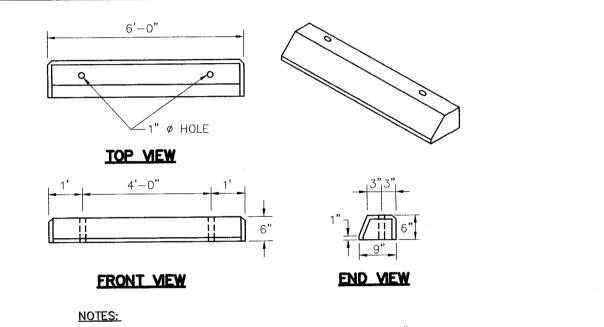


1. THE TOP AND ALL EXPOSED FACE SURFACES TO 1" BELOW GUTTER LINE SHALL HAVE A SPONGE FLOAT SURFACE. 2. ALL EXPOSED EDGES SHALL HAVE A 3/4" CHAMFER 3. PRECUTS CONCRETE CAR STOPS INCLUDE FURNISHING AND DRIVING 3/4"x 18" STEEL RODS.

PRECAST CONCRETE PARKING STOP N.T.S.

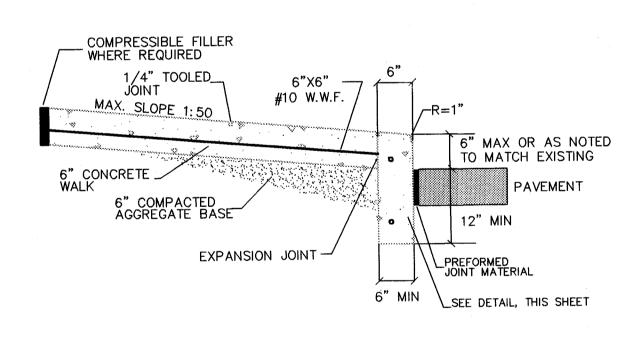

INTEGRAL CONCRETE WALK & CURB DETAIL

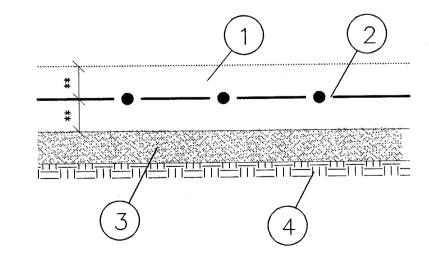

** = 3" FOR SITE CONCRETE SLABS; 4" FOR DRIVE APRONS AND DUMPSTER PAD

CONCRETE PAVEMENT/DRIVE APRON DETAIL

N.T.S. ODOT ITEM

DESCRIPTION


1 - SITE CONCRETE - 451 6" REINFORCED PORTLAND CEMENT CONCRETE PAVEMENT, MIN. 3500 PSI COMPRESSIVE STRENGTH.


DRIVE APRONS AND DUMPSTER PAD - 451 8" REINFORCED PORTLAND CEMENT CONCRETE PAVEMENT, MIN. 3500 PSI COMPRESSIVE STRENGTH.

2 - 6"x6" $- W2.9 \times W2.9 W.W.F.$

3 - 304 6" AGGREGATE SUBBASE (CRUSHED 304 VIRGIN LIMESTONE ONLY) 4 - 204 COMPACTED SUBGRADE


NOTES: WHEN CONCRETE WALKS END AT DRIVE APRON, CONTRACTOR SHALL TOOL JOINTS IN APRON TO CONTINUE THE WALK THROUGH THE APRON.

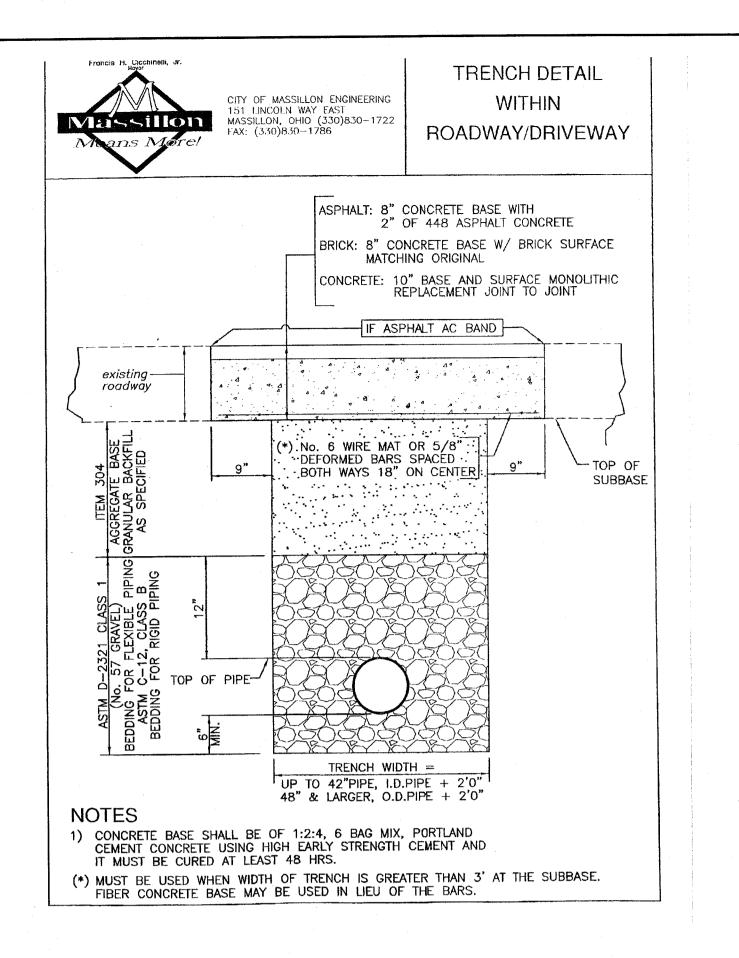

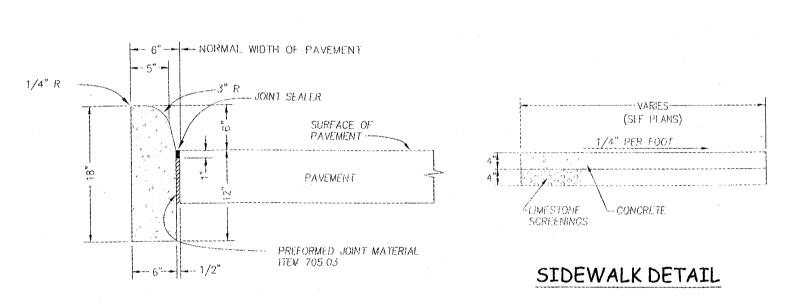


ODOT TYPE 6 CURB

DETAILS FOR WORK IN RIGHT-OF-WAY N.T.S.

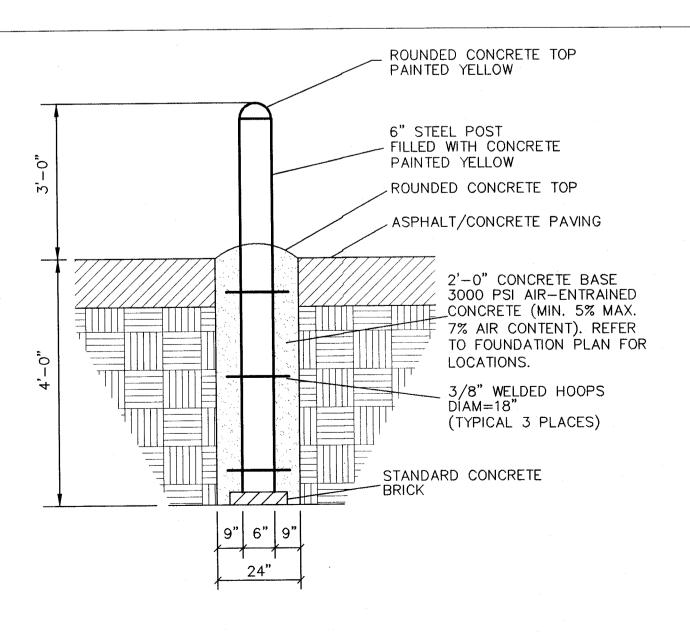


BOLLARD DETAIL

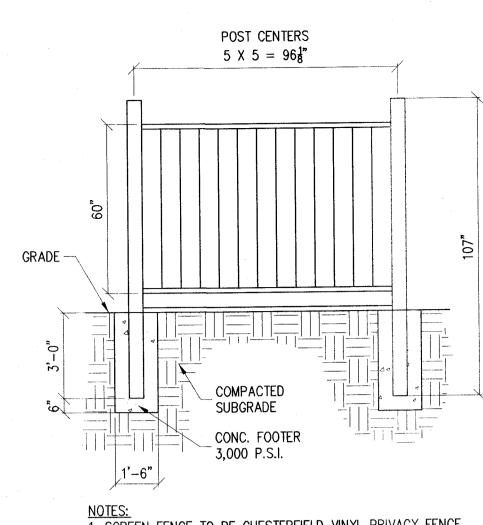


1. SCREEN FENCE TO BE CHESTERFIELD VINYL PRIVACY FENCE, 6'-0" HIGH / 8'-0" WIDE AS MANUFACTURED BY BUFFTECH AND SUPPLIED BY AUBURN FENCE (440) 543-4805; OR APPROVED EQUAL. COLOR TO BE WHITE. 2. INSTALL PER MANUFACTURER'S SPECIFICATIONS.

PRIVACY FENCE DETAIL

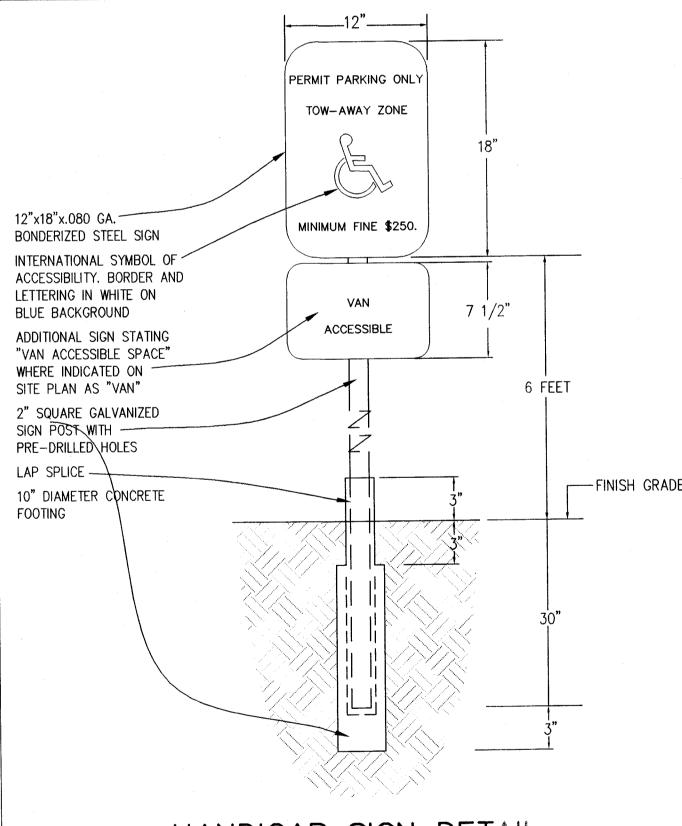


HANDICAP SIGN DETAIL

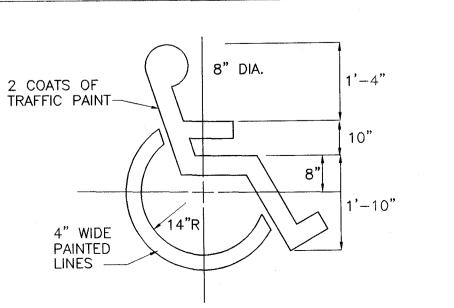

HANDICAP SYMBOL

CAMPBELL & ASSOCIATES, INC

Surveying Engineering $(330) \cdot 945 - 4117$ 1923 Bailey Road Suite A Cuyahoga Falls, Ohio 44221 WWW.CAMPBELLSURVEY.COM

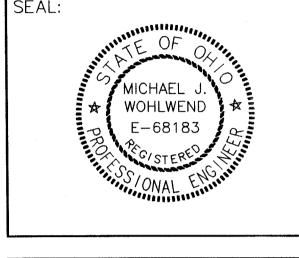



8248

(216) 221-6500

STORE NUMBER. NWC LINCOLNWAY EAST AND WALES ROAD

DEAL TYPE

DEVELOPER: 14600 DETROIT AVENUE LAKEWOOD, OHIO 44107

MASSILLON, OHIO (STARK COUNTY)



REVISIONS:

BID SET 2010-02-08 ADDENDUM / 2010-02-26

LAYOUT COORD

PLANNING MGR DRAWING BY

DATE:


JOB NUMBER

CONSTRUCTION **DETAILS**

2010-01-11

20090146

COMMENTS:

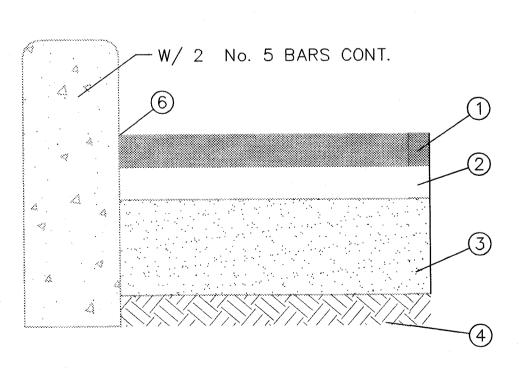

CURB/ASPHALT DETAIL

DESCRIPTION ODOT ITEM


1 - 448 1-1/2" ASPHALT CONCRETE SURFACE COURSE, TYPE 1


2 - 448 2-1/2" ASPHALT CONCRETE INTERMEDIATE COURSE, TYPE 2

3 – 304 9" AGGREGATE BASE 4 - 204 COMPACTED SUBGRADE

5 - 609 CONCRETE CURB TYPE 6 PER ODOT STD DWG BP-5.1, WITH 2 NO. 5 BARS AS SHOWN. INSTALL GUTTER SHIELD.


NOTE: AGGREGATE BASE TO BE VIRGIN LIMESTONE ONLY.

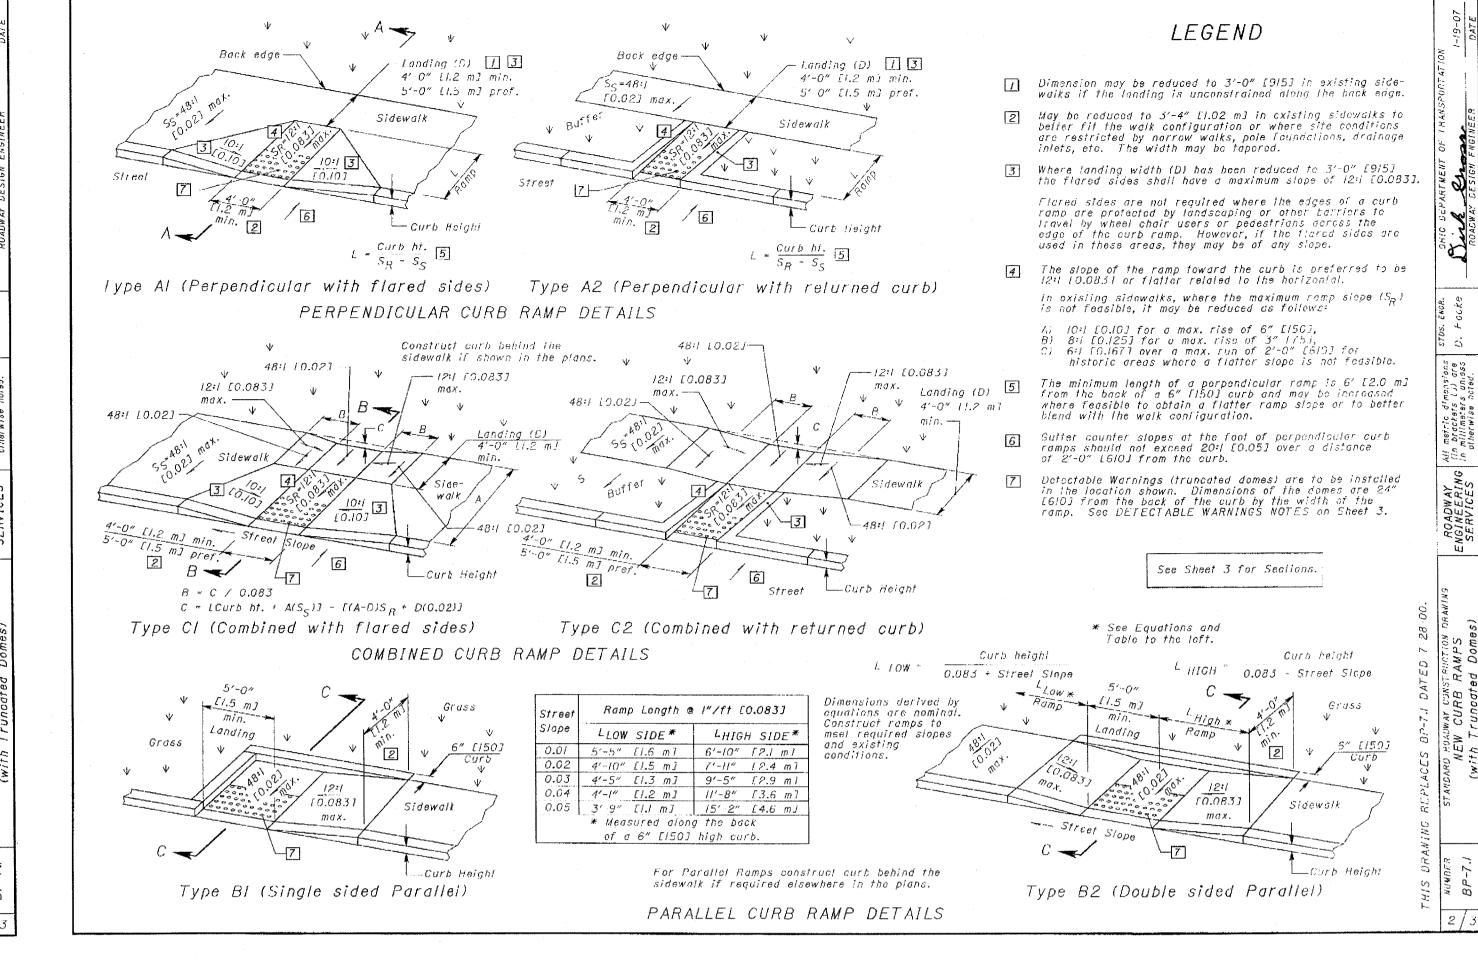

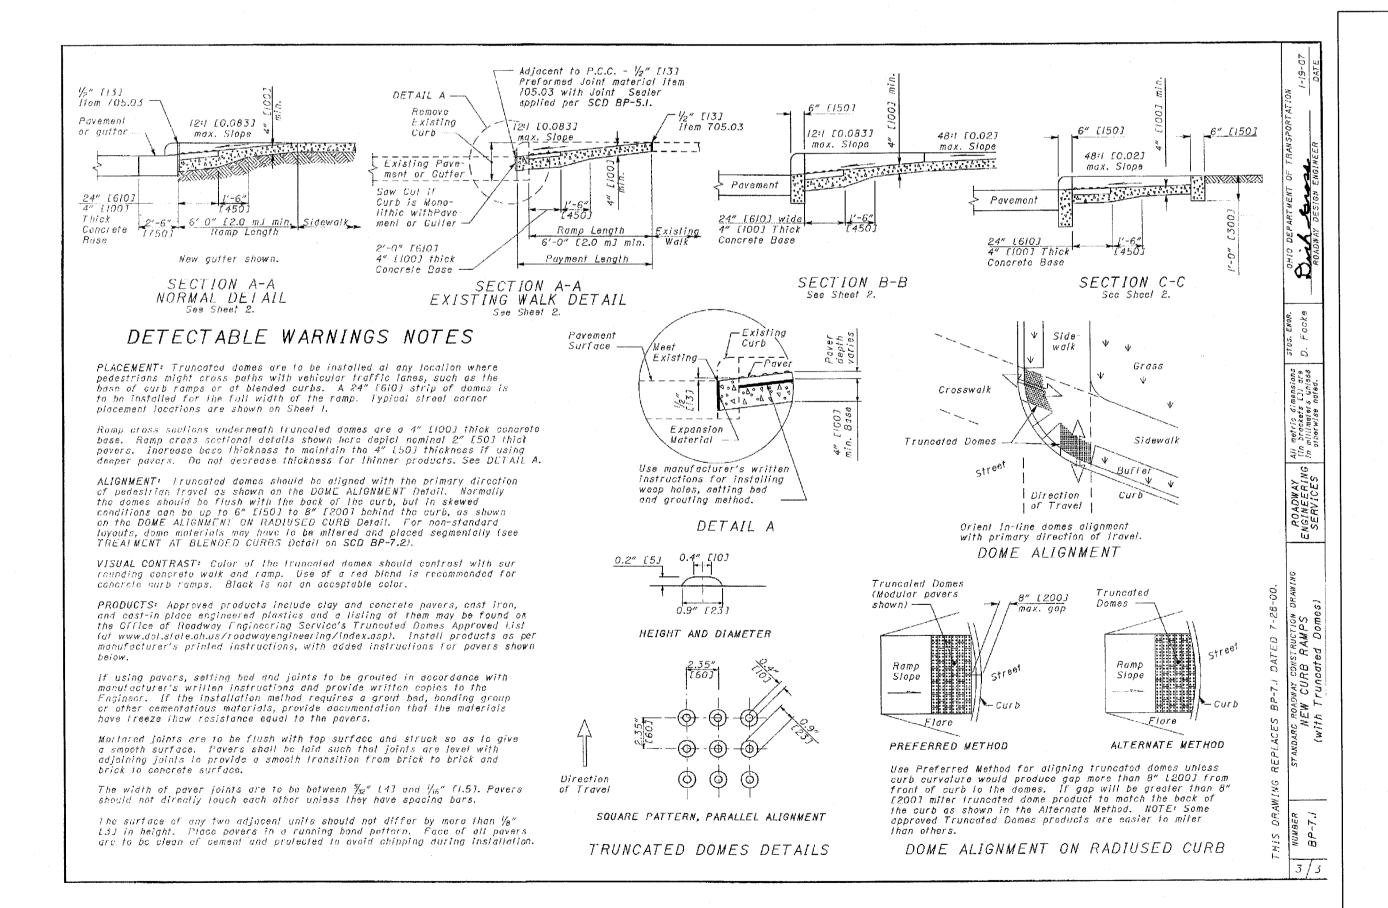

domes), grading, forming, and finishing of the curb and walk of the curb ramp.



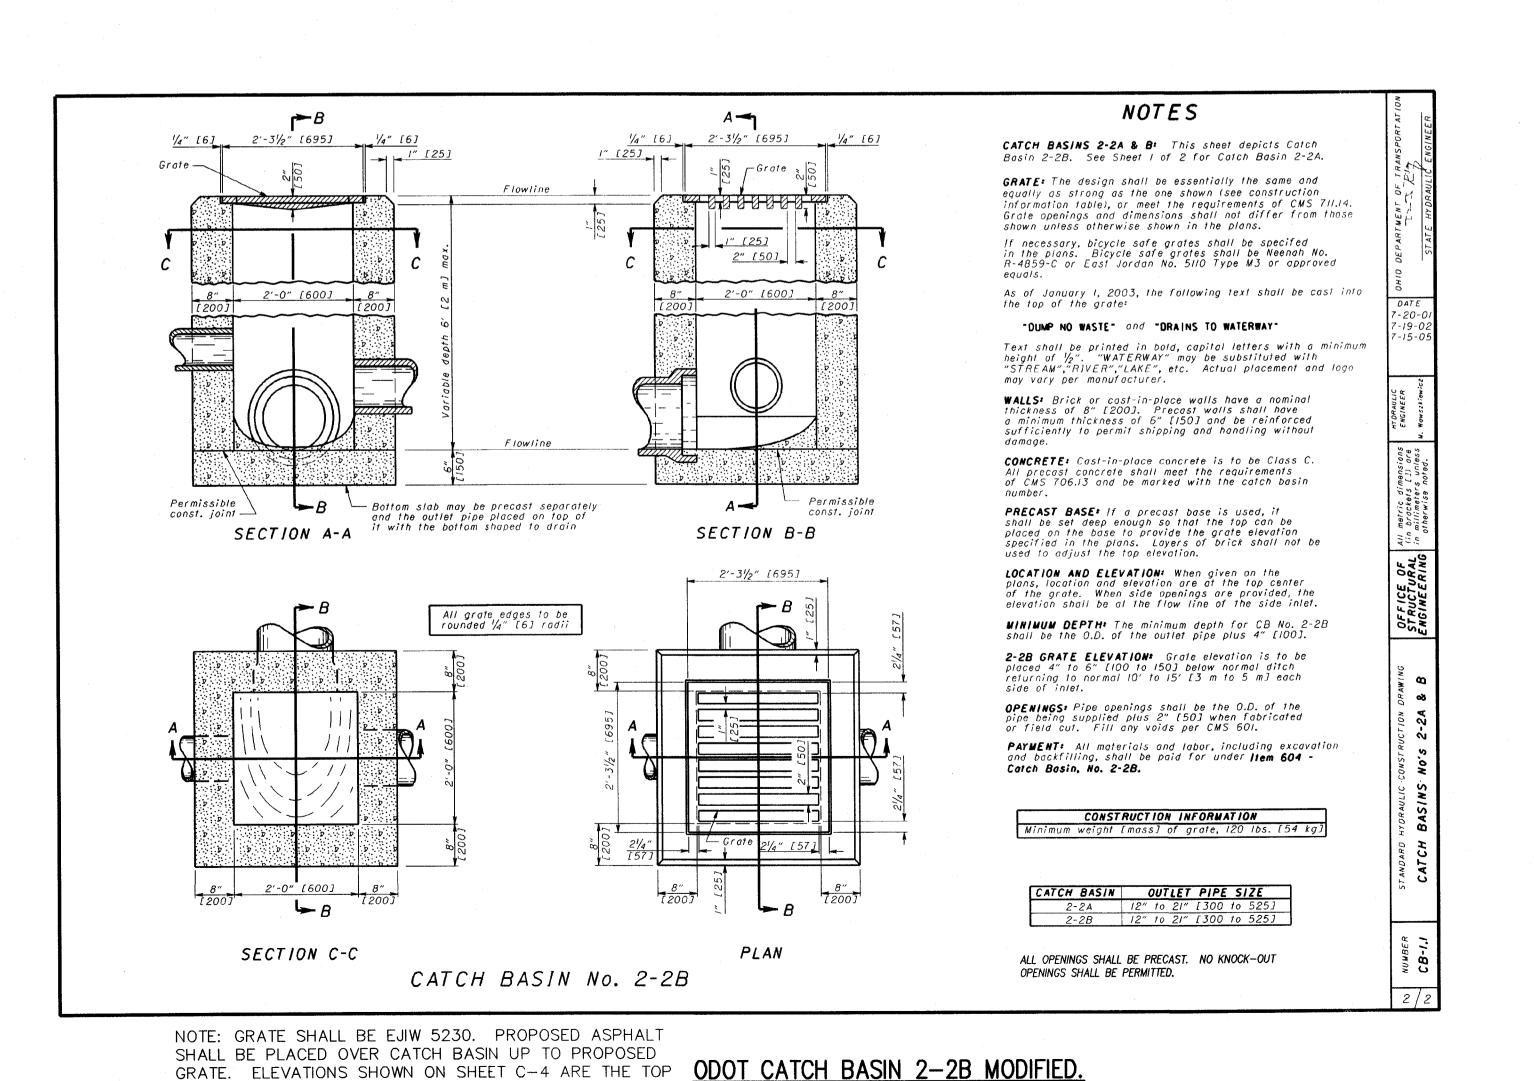


OF GRATE ELEVATION.



CAMPBELL & ASSOCIATES, INC.
Surveying Engineering

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STORE NUMBER

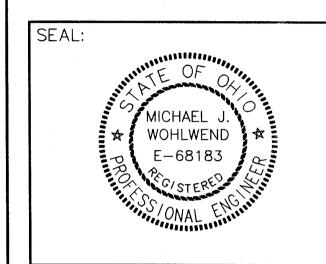NWC LINCOLNWAY EAST AND WALES ROAD MASSILLON, OHIO (STARK COUNTY)

DEAL TYPE:

DEVELOPER: 14600 DETROIT AVENUE LAKEWOOD, OHIO 44107



(216) 221-6600

REVISIONS:

BID SET 2010-02-08
ADDENDUM 2 2010-02-26

AYOUT COORD:

LAYOUT COORD: PLANNING MGR.

ATE: 2010-01-11

JOB NUMBER: 20090146


TITLE:

CONSTRUCTION DETAILS


C-9

CITY OF MASSILLON ENGINEERING 151 LINCOLN WAY EAST MASSILLON, OHIO (330)830-1722 FAX: (330)830-1786

MANHOLE TYPE 3

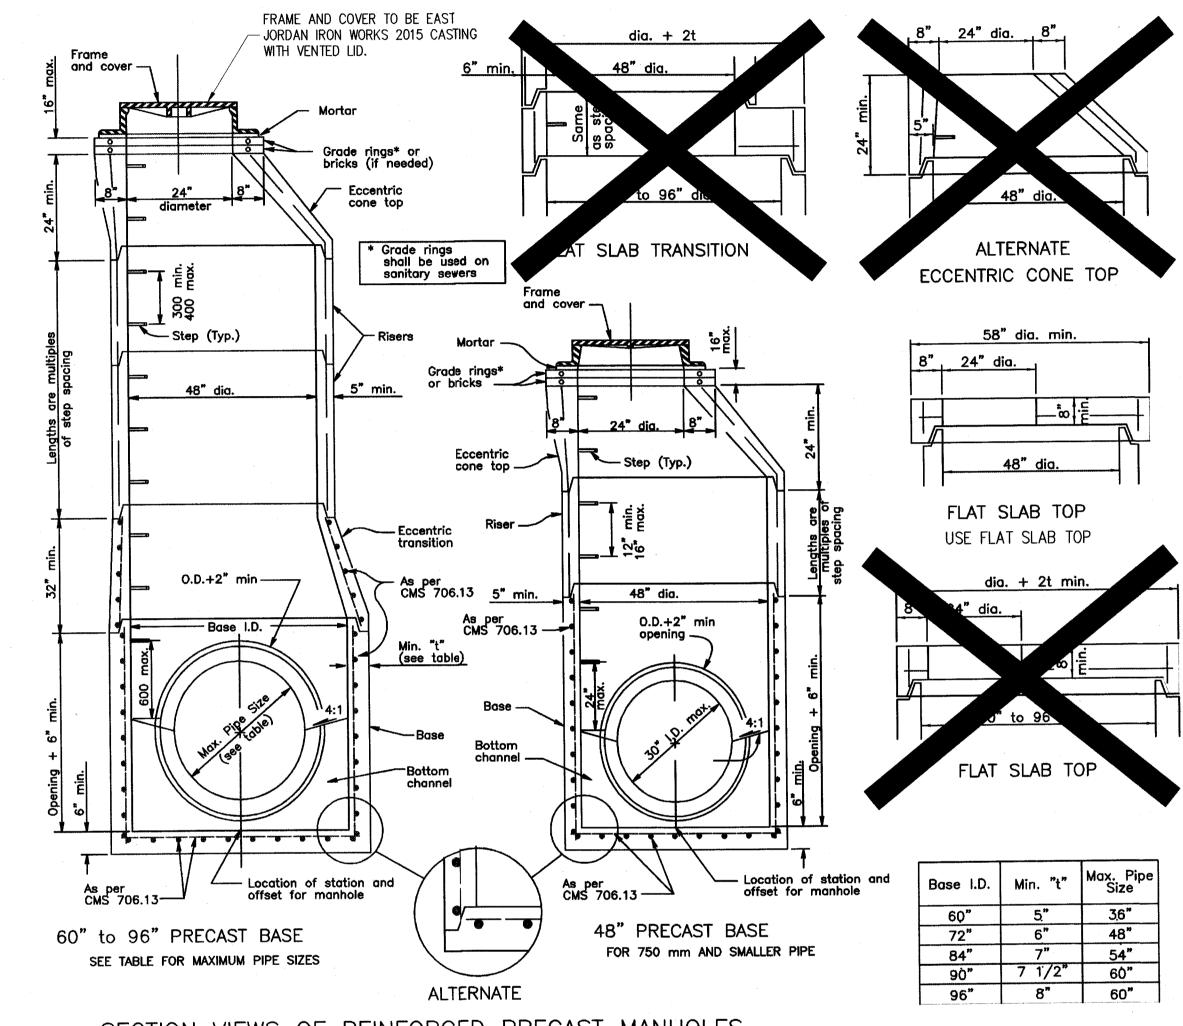

SECTION VIEWS OF REINFORCED PRECAST MANHOLES

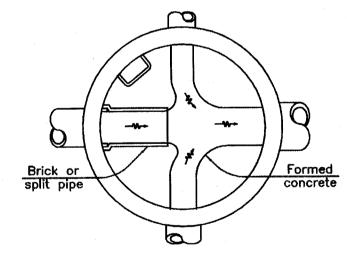

SECTION BELOW SPRING LINE
Showing method of turning side drain which enter the manhole at the flowline

NOTES

GENERAL: With normal soil and site conditions this standard precast manhole may be used for any required manhole depth.

Sections of the precast manhole shall be cast and assembled with either all tongue or all groove ends up. Lift holes may be provided in each section for handling.

TOP AND TRANSITION (OR REDUCER): This section shall be a flat slab unless an eccentric cone is specified.

BASE: Manhole No. 3 is shown with a monolithic floor and riser which may be cast in one or two operations. A permissible alternate is to cast and ship the floor and barrel separately. Openings for inlet and outlet pipes shall be provided, either when

Bottom channels may be formed of concrete, precast in the base or field constructed as shown

RISER SECTIONS: Openings for 18" and smaller inlet pipes may be either prefabricated, or cut in the field provided the sides of the pipe at the springline do not project into the manhole.


CONNECTIONS: Connections between precast manhole sections and pipes on sanitary sewers may be sealed with resilient connectors conforming to ASTM C 923.


JOINT SEAL: Seal between precast manhole sections on sanitary sewers shall be resilient and flexible gasket joints per CMS 706.11.


MATERIALS: Materials for bases and other precast sections, including reinforcement not specified hereon, shall comply with the requirements of CMS 706.13.


DROP PIPE: When specified on the plans, drop pipe shall be constructed as shown on MH—3.1M.

STEPS, FRAMES AND COVERS: Shall comply with the requirements set forth on MH—1.1M.

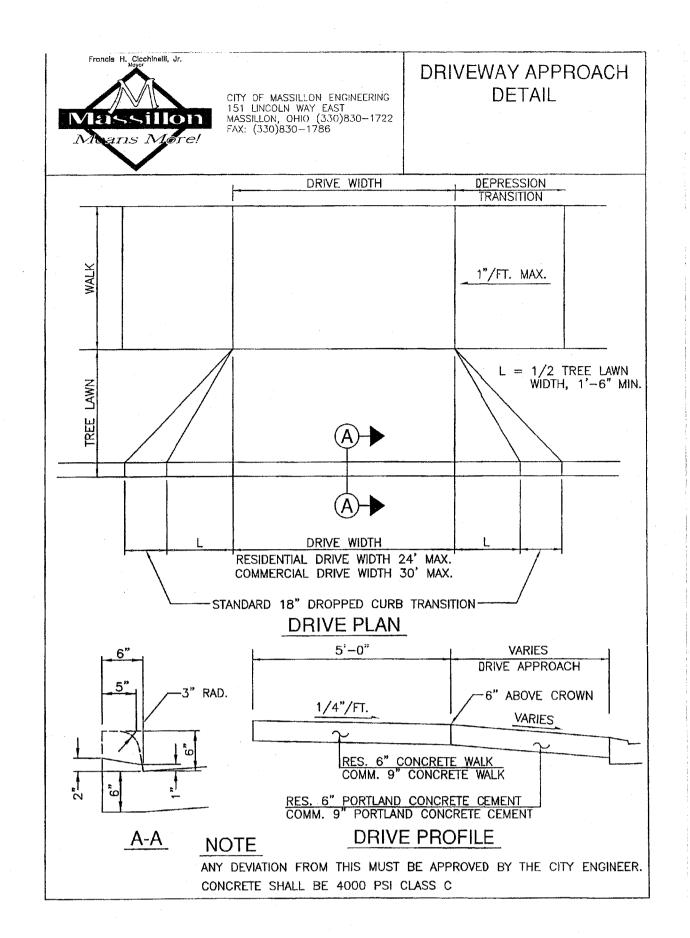

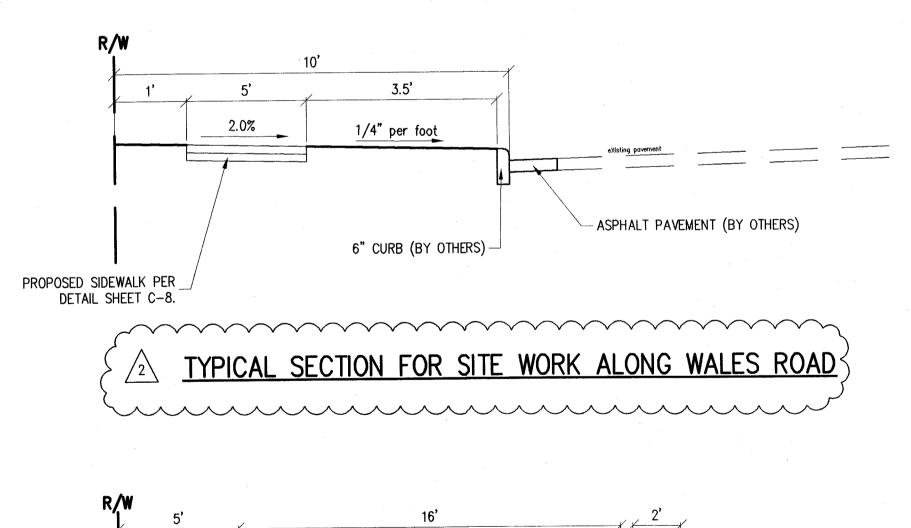

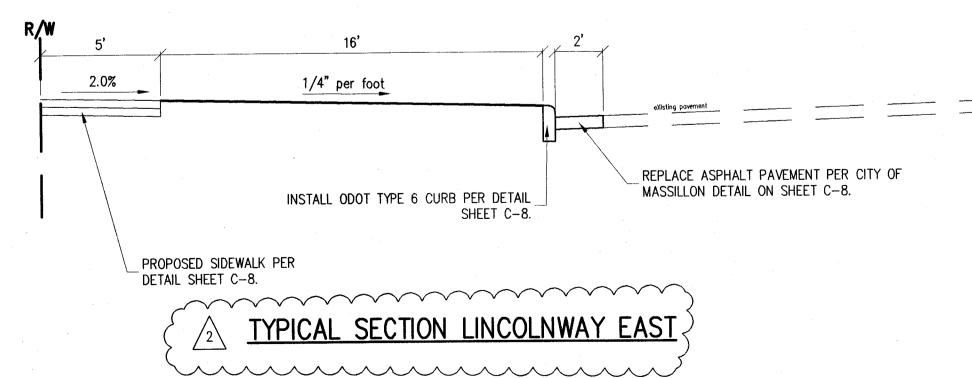


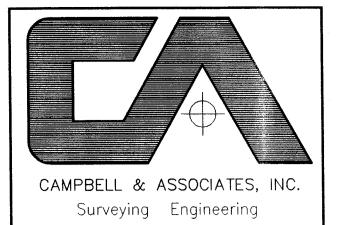

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Cuyahoga Falls, Ohio 44221 WWW.CAMPBELLSURVEY.COM



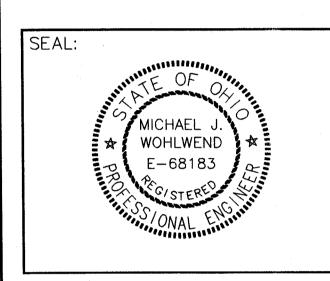

STORE NUMBER

NWC LINCOLNWAY EAST AND WALES ROAD MASSILLON, OHIO (STARK COUNTY)

DEAL TYPE

DEVELOPER: 14600 DETROIT AVENUE LAKEWOOD, OHIG 44107 (216) 221-6600



REVISIONS:

BID SET 2010-02-08
ADDENDUM 2 2010-02-26

LAYOUT COORD:
PLANNING MGR.

DRAWING BY: JJF

DATE: 2010-01-11

JOB NUMBER: 20090146

CONSTRUCTION DETAILS

SHEET NUMBER:


C-10

2. QUALITY AND SIZES OF PLANTS TO MEET AMERICAN ASSOCIATION OF NURSERYMAN STANDARDS.


- 3. LANDSCAPE ARCHITECT TO BE AUTHORITY FOR INTERPRETATION OF PLAN AND GUALITY OF WORK,
- 4. ALL SUBSTITUTIONS OF SIZES OR VARIETIES SUBJECT TO APPROVAL OF LANDSCAPE ARCHITECT.
- 5. IF QUANTITIES LISTED IN PLANT MATERIAL LIST DO NOT CORRELATE WITH PLANTINGS INDICATED ON PLAN, THE QUANTITIES INDICATED ON THE PLAN SHALL GOVERN.
- 6. CONTRACT SHALL CONSIST OF TOTAL UNITS AUTHORIZED BY OWNER.
- J. ALL WALL ELEVATIONS, FINISHED GRADES, AND DRAIN LINE ELEVATIONS TO BE FINALIZED IN THE FIELD WHERE APPLICABLE.
- 6. THE LANDSCAPE CONTRACTOR TO LOCATE ALL UNDERGROUND UTILITIES AND/OR SPRINKLER SYSTEMS BEFORE INSTALLATION. 4. THE LANDSCAPE CONTRACTOR IS RESPONSIBLE FOR ALL CLEAN-UP ASSOCIATED WITH HIS CONSTRUCTION PROCEDURE.
- IO. ALL LAWN AREAS TO RECEIVE A MINIMUM 2" TOPSOIL; ALL PLANTING AREAS TO RECEIVE A MINIMUM 6" TOPSOIL.
- II. PLANTING BED PREPERATION: LOOSEN EXISTING SOIL; ADD TOPSOIL IN SUFFICIENT QUANTITY TO RAISE BED 4-5" ABOVE FINISHED LAWN GRADE. PROVIDE POSITIVE DRAINAGE AWAY FROM ALL BUILDINGS AND AROUND OR AWAY FROM PLANTING BEDS TO PREVENT PONDING OF WATER. DO NOT RAISE BED GRADES, FINISHED GRADES, OR MULCH ABOVE FINISHED FLOOR ELEVATIONS.
- 12. USE SOIL MIXTURE IN ALL PLANTING PITS. SOIL MIXTURE TO BE 1/4 ORIGINAL ON-SITE SOIL AND 3/4 SANDY LOAM OR LOAM SOIL AS DEFINED BY USDA SOIL CONSERVATION SERVICE, SOIL CLASSIFICATION SYSTEM. FREE FROM ADMIXTURE OF SUBSOIL, HEAVY CLAY, COARSE SAND, STONES, PLANTS, ROOTS, STICKS, AND ANY OTHER FOREIGN MATERIALS. 45% OF TOPSOIL SHALL PASS A 2.0 MIL SLEVE. ORGANIC CONTENT SHALL BE 4% TO 12% OF TOTAL DRY WEIGHT. ADD GRANULAR 'SOIL MOIST' TO TOPSOIL MIX, APPLIED PER MANUFACTURER'S RECOMMENDED RATES FOR THE SIZE AND TYPE OF PLANT MATERIAL SPECIFIED, IF NO IRRIGATION IS APPLIED.
- A. IF THE QUALITY OR QUANTITY OF ON-SITE TOPSOIL STOCKPILED IS INSUFFICIENT TO COMPLETE WORK, PROVIDE IMPORTED TOPSOIL. OBTAIN RIGHTS AND PAY ALL COSTS FOR IMPORTED TOPSOIL MATERIAL.
- B. PROPOSED TOPSOIL SHALL BE ACCEPTABLE TO ARCHITECT AND SOILS TESTING FIRM.
- 13. MULCH ALL PLANTING BEDS, AND DISTURBED AREAS WITH A 3" DEPTH OF DOUBLE SHREDDED HARDWOOD BARK. INSTALL WEED MAT WEED BARRIER UNDER ALL MULCHED PLANTING AREAS. PROVIDE 4.1 OZ., WOVEN POLYPROPYLENE, NEEDLE-PUNCHED FABRIC, WEED BARRIER. SECURE IN PLACE WITH SOIL STAPLES.
- 14. ALL NYLON ROPING, TWINE, SHALL BE REMOVED, PRIOR TO PLANTING. ALL NON-TREATED BURLAP AND/OR NON-ROT PROOF BURLAP TO BE REMOVED FROM TOP HALF OF ROOTBALL. ALL TREATED BURLAP OR POLYPROPYLENE BURLAP TO BE COMPLETELY REMOVED FROM PLANTING PIT.
- 15. APPROPRIATE QUANTITIES OF 20-10-5 AGRIFORM SOLID FERTILIZER TABLETS (OR EQUAL) TO BE APPLIED TO ALL PLANTINGS.
- 16. SEEDING MIXTURE: SEED SHALL BE 5 WAY BLEND PERENNIAL RYE GRASS, COMPOSED OF 20% MANHATTAN 3 PERENNIAL RYE, 20% AFFINITY PERENNIAL RYE, 20% MONTEREY PERENNIAL RYE, 20% CATALINA PERENNIAL RYE, 20% PENNANT 2 PERENNIAL RYE.
- 17. SODDING: ALL SOD SHALL BE A MIXTURE OF DISEASE RESISTANT KENTUCKY BLUEGRASS SOIL GROWN SOD. ALL SOD SHALL BE LAID ON A MINIMUM OF 2" TOPSOIL AND SOIL GROWN. FERTILIZE WITH A NON-BURNING MEASURED RELEASE FERTILIZER, OR RAKE IN A LIGHT APPLICATION OF 12-12-12 AT A RATE OF 5LB. PER 1000 S.F. BEFORE LAYING SOD.
- 18. ALL AREAS TO BE SEEDED OR SODDED ARE TO BE FREE FROM WEEDS AND ROCKS 3/4" OR LARGER. ALL SEEDED AREAS ARE TO BE COVERED WITH A 1-1/2" THICK, NON-COMPACTED LAYER OF STRAW WITH APPLIED TACKIFIER PER MANUFACTURER'S SPECIFICATIONS.
- 19. GRADING: THE BUILDER WILL PROVIDE A FINISHED GRADE WITHIN 3" OF FINAL GRADE. THE LANDSCAPE CONTRACTOR IS RESPONSIBLE FOR ALL FINE GRADING RELATING TO HIS WORK (WHEN APPLICABLE).
- 20. ALL BEDS SHALL BE EDGED TO FORM A DEFINED, CUT EDGE.
- 21. RESEED OR SOD ALL DISTURBED AREAS WITH APPROPRIATE MIXTURE.
- 22. MAINTAIN LAWNS THROUGH TWO CUTTINGS AND ASSUME FULL RESPONSIBILITY FOR A FULL AND HEALTHY GROWTH. RESEED ALL BARE SPOTS.
- 23. ALL PLANT MATERIALS AND GROUNDCOVERS TO BE INSPECTED AND APPROVED BY LANDSCAPE ARCHITECT BEFORE FINAL ACCEPTANCE OF WORK.
- 24. GUARANTEE PERIOD:

A. GUARANTEE PERIOD SHALL BEGIN AT THE ISSUANCE OF THE CERTIFICATE OF COMPLETION AND SHALL END EXACTLY ONE YEAR FROM THAT DATE. B. AT THE CONCLUSION OF THE GUARANTEE PERIOD, A FINAL INSPECTION OF THE WORK WILL BE MADE TO DETERMINE THE CONDITION OF THE PLANT MATERIAL. ALL PLANT MATERIAL NOT IN A HEALTHY OR 40% DEFOLIATED GROWING CONDITION WILL BE NOTED.

C. REMOVE THE MATERIAL SO NOTED FROM THE SITE AT THE DIRECTION OF THE ARCHITECT AND REPLACE DURING THE FOLLOWING PLANTING SEASON WITH THE MATERIALS OF LIKE KIND AND SIZE, AND IN A MANNER SPECIFIED FOR THE ORIGINAL PLANTING AT NO EXTRA COST. D. GUARANTEE PERIOD ALSO APPLIES TO REPLACED MATERIAL.

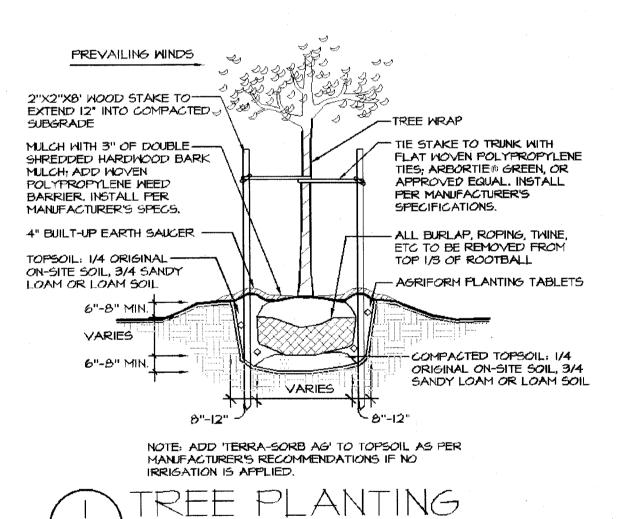


NOT TO SCALE

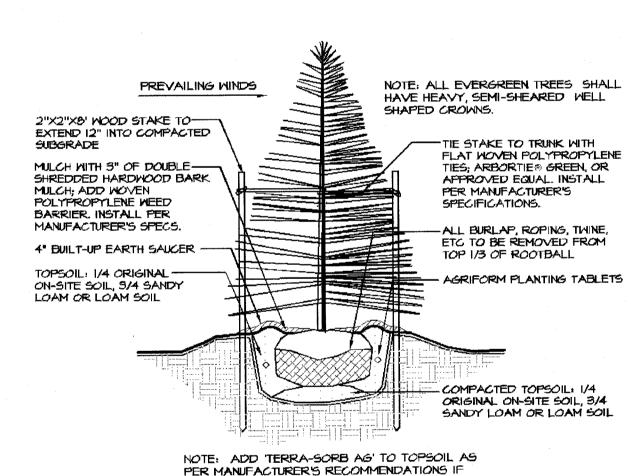


/ERGREEN PLANTING

NO IRRIGATION IS APPLIED.

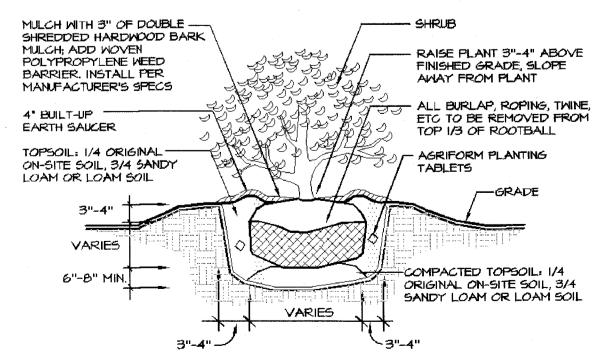

NOTE: ADD TERRA-SORB AG' TO TOPSOIL AS PER MANUFACTURER'S RECOMMENDATIONS IF NO



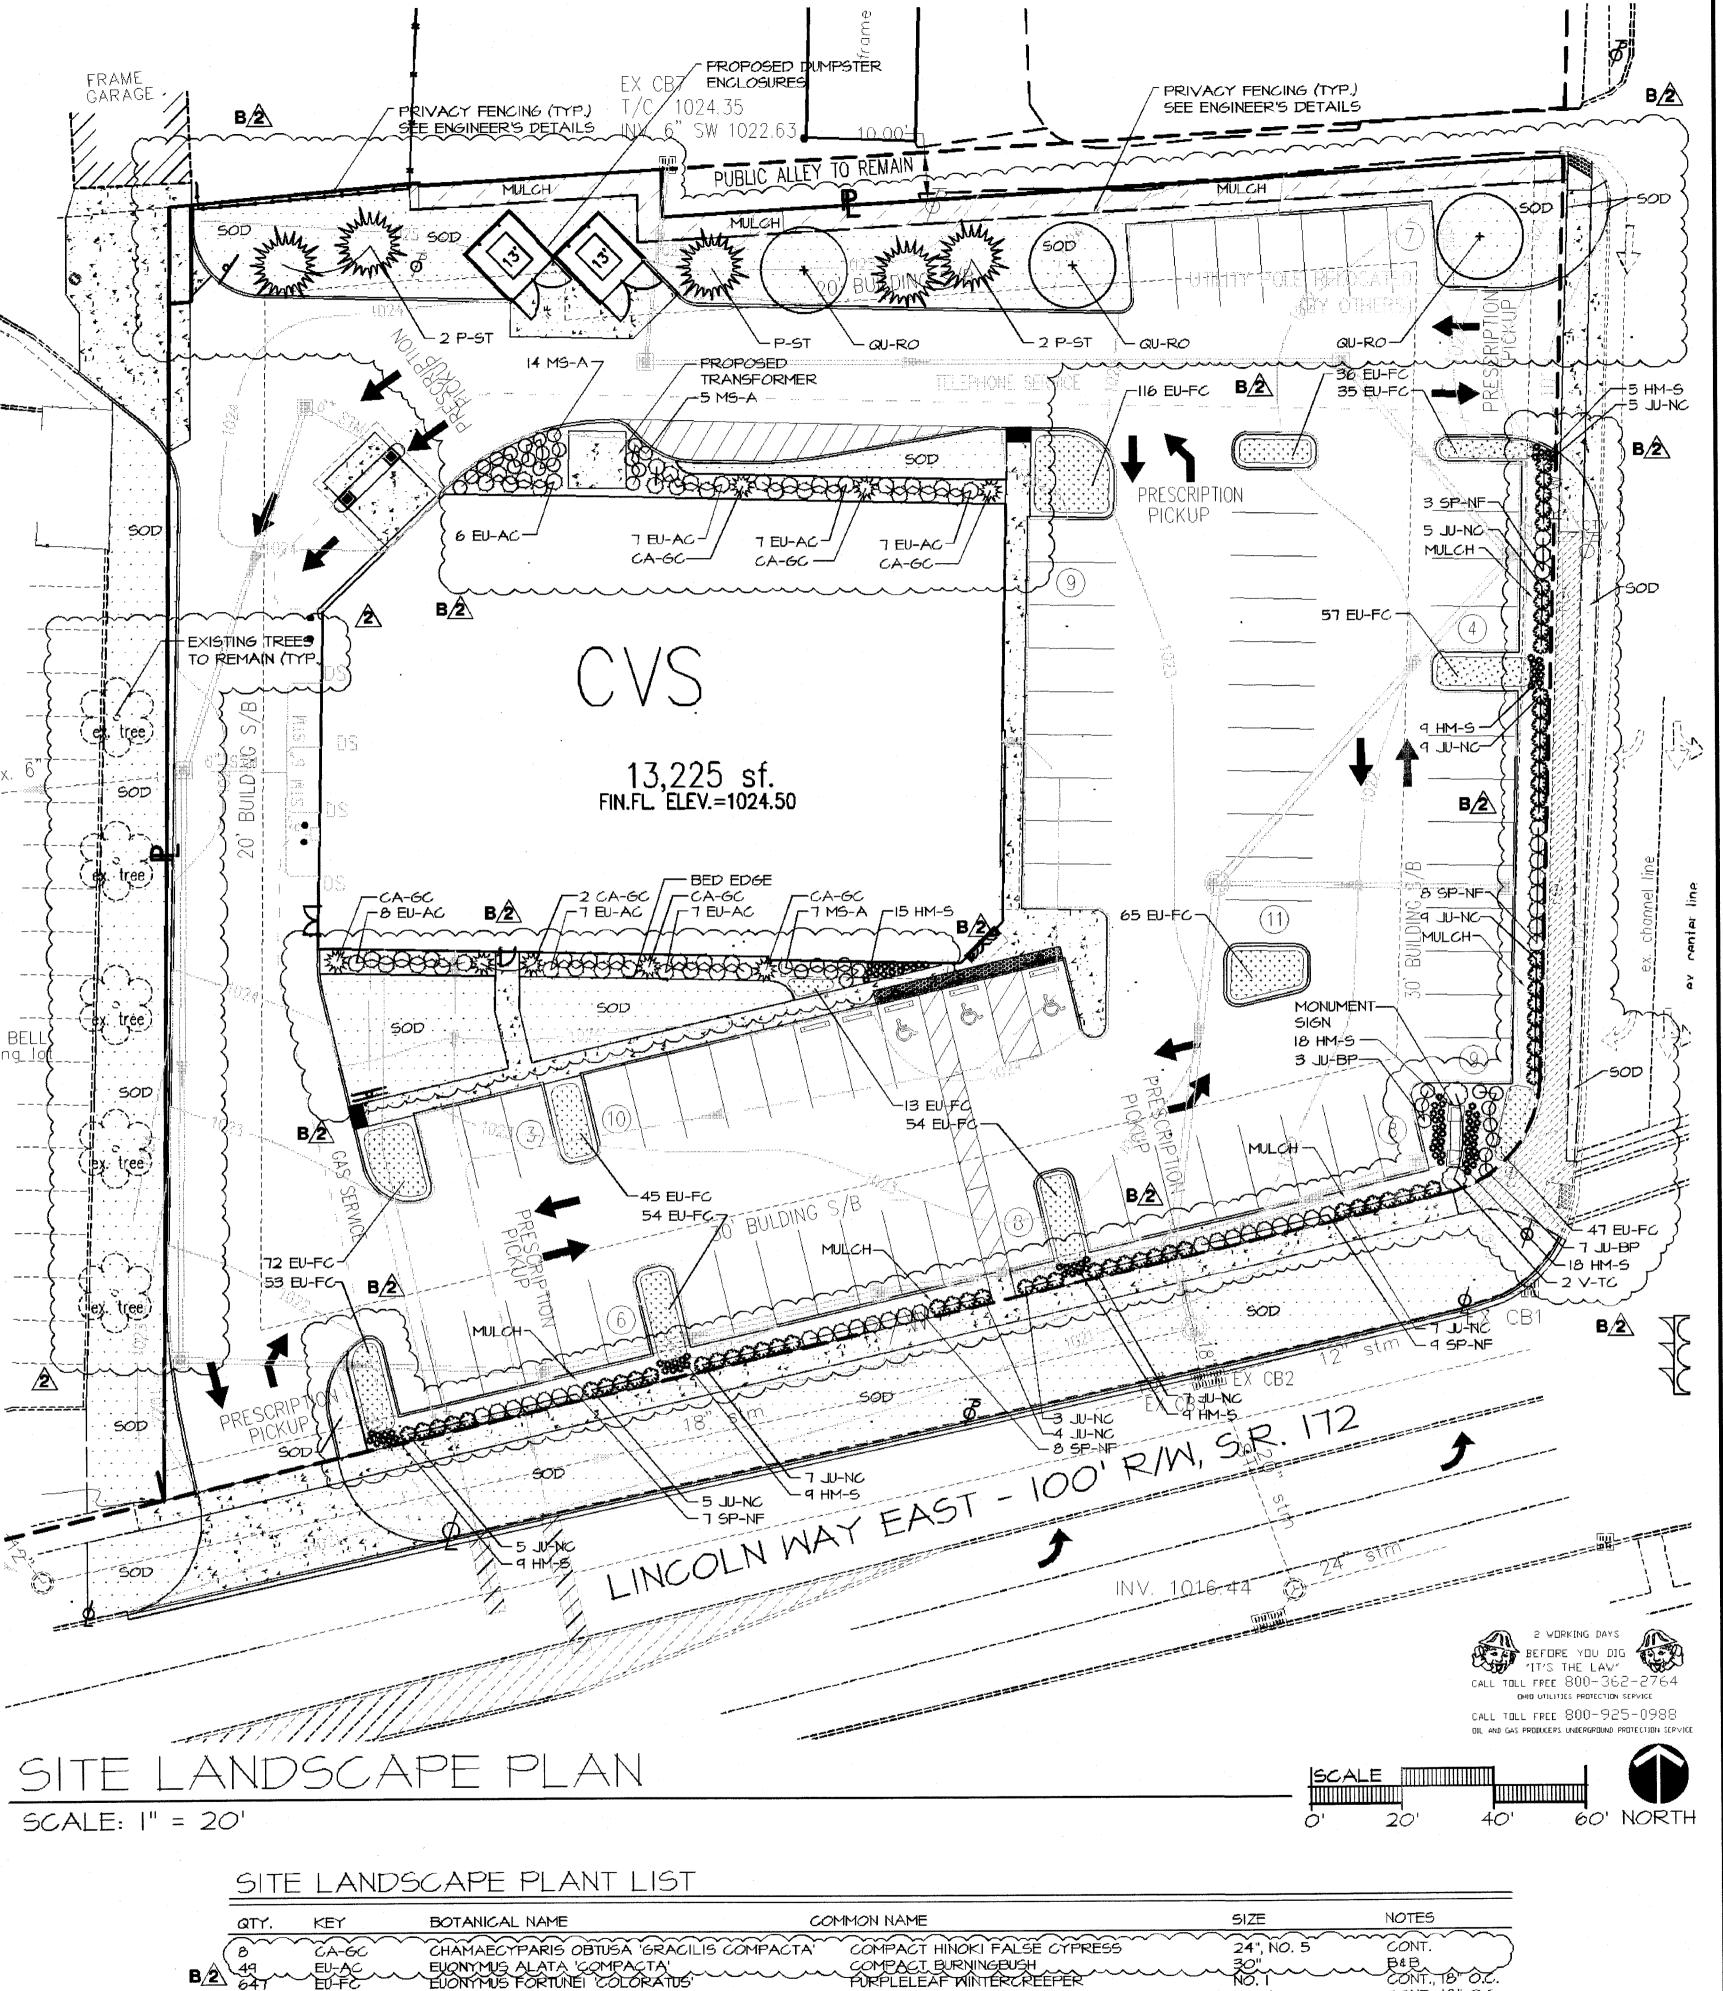

STELLA D'ORO DAYLILY

NICK'S COMPACT PELTZER ADAGIO JAPANESE MAIDEN GRASS

ÉASTERN DHITE PHNE

~ COMPACT AMERICAN CRANBERRY BUSH ~ ~ AMIT. ~ ~ BAB^

BLUE PACIFIC JUNIPER

HEMEROCALLIS 'STELLA D'ORO'

MĬŚČÁNŤHUŚ ŚIŇĚNŚIS "ADAĞIO"

JUNIPERUS CONFERTA BLUE PACIFIC

IUNIPERUS CHINENSIS NICK'S COMPACT

HM-S

JU-BP

B/2 5 PINOS STROBOS

PL

Date Notes 02-08-10 FOR BID 02-26-10 ADDENDUM /2 04-06-10 BULLETIN /2

Job No: 09060 File: 040610 evs massillon LP.dwg

CONT., 18" O.C.

CONT., 24" O.C.

~ CONI.

NO. 2

18", NO. 3

JB", NQ, 3,-

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RSE & ASSOCIATES, IN pe Architecture · Land Plannin ashington Street · Chagrin Falls. OH 440%



SRD, MASSILLON, OH

CVS MASSILLON

WELINCOLN WAY EAST AND WAI

Date Notes

02-08-10 FOR BID
02-16-10 ADDENDUM 1
02-26-10 ADDENDUM 2
04-06-10 BULLETIN 2

Job No: 09060 File: 040610 eys massillon LP.dwg

I-1

31691 DEQUINDRE RD MADISON HEIGHTS, MI 48071

WWW.JohnDeereLandscapes.com ___jparko@JohnDeereLandscapes.com

PH: (248) 588-1141 FX: (248) 588-1963

Sheet 2 of 3

EXTERIOR WALL

SPECIFY 3, 6, 9, 12, 15 STATION MODEL CONTROLLER. MOUNT CONTROLLER WITH LCD SCREEN AT EYE LEVEL. CONTROLLER SHALL BE HARD-WIRED TO

Illumiter IRRIGATION DETAIL

PRO-C CONTROLLER


1) STANDARD VALVE BOX (2) FINISH GRADE REMOTE CONTROL VALVE (3) MODEL PGV-100G WITHOUT FLOW CONTROL 4) WATERPROOF CONNECTORS (2) (5) 18-24" COILED WIRE 8 BRICK SUPPORTS (4) (9) 3/4" MINUS WASHED GRAVEL

Illumiter IRRIGATION DETAIL

PGV GLOBE VALVE

1. SLEEVE BELOW ALL HARDSCAPE ELEMENTS WITH CLASS 200 PVC TWICE THE DIAMETER OF THE PIPE OR WIRE BUNDLE WITHIN. 2. FOR PIPE AND WIRE BURIAL DEPTHS SEE SPECIFICATIONS

PIPE & WIRE TRENCHING NOT TO SCALE

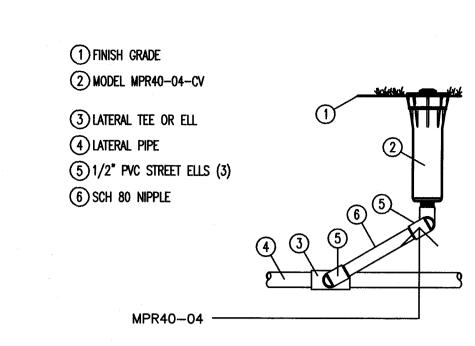

(1) FINISH GRADE

MODEL HQ-XX-XXX
QUICK COUPLER VALVE

4 PREFABRICATED SWING JOINT

(3) 10" ROUND VALVE BOX

(5) MAIN LINE TEE OR ELL

7) BRICK SUPPORT (3)

(8) 3/4" MINUS GRAVEL


(9) #4 REBAR W/SS HOSE CLAMPS

Illumber IRRIGATION DETAIL

(6) MAIN LINE PIPE

Illumber IRRIGATION DETAIL MP ROTATOR SPRINKLER NOT TO SCALE



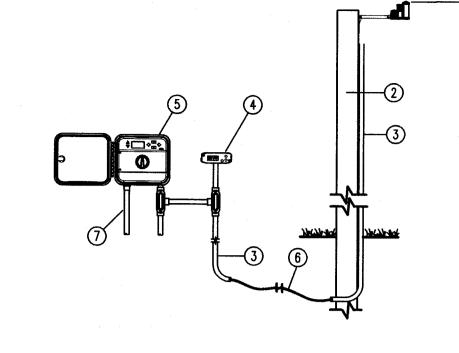

1) MODEL: SOLAR SYNC SENSOR

SUITABLE POST OR POLE MOUNT. MIN 6ft. 2) ABOVE TURF, MOUNT IN LOCATION THAT MAXIMIZES DIRECT SUNLIGHT

3 CONDUIT FROM SOLAR SYNC SENSOR TO SOLAR SYNC MODULE MODEL SOLAR SYNC MODULE MOUNT LESS THAN 6' AWAY FROM CONTROLLER. MODULE CAN BE MOUNTED INTERNALLY WHEN PAIRED WITH THE PCC CONTROLLER. "

5 COMPATIBLE HUNTER CONTROLLERS:

6 COMMUNICATION WIRE FROM MODULE TO SENSOR. MAX 200 FT WIRE DISTANCE (7) POWER SOURCE

WIRE FROM MODULE TO SENSOR SHALL BE 18/2. USE CONTROLLER SMART PORT TO CONNECT TO MODULE UNIT.

Domber IRRIGATION DETAIL

PRESSURE-COMPENSATING IN-LINE EMITTER

TUBING: NETAFIM TLDL

2 EMITTER (PRE-INSTALLED ON TUBING)

4) 1/2-INCH COMPRESSION TEE

3 PLANT MATERIAL

SOLAR SYNC SYSTEM

2) FINISH GRADE DRIP ZONE KIT 3 MODEL PCZ-101-XX TIP FILTER 45 DEGREES (4) WATERPROOF CONNECTORS (2) (5) 18-24" COILED WIRE 9 3/4" MINUS WASHED GRAVEL (10) REGULATOR: 25 or 40 PSI


1 JUMBO VALVE BOX

(11) PVC SLIP UNIONS

Thurster IRRIGATION DETAIL

6 DRIP CONTROL ZONE
1-2) NOT TO SCALE


NETAFIM DRIP LINE (1-2) NOT TO SCALE

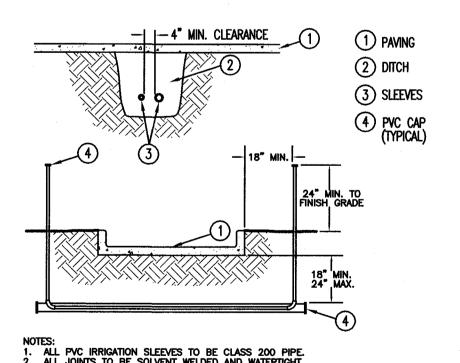


5 QUICK COUPLER VALVE

[1-2] NOT TO SCALE

SLEEVING NOT TO SCALE

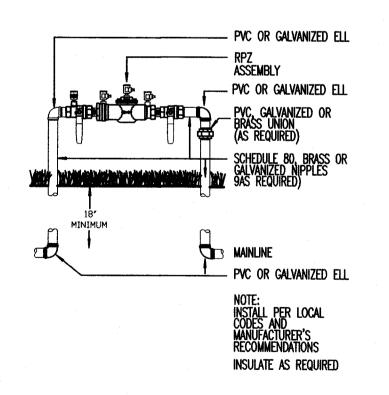

RPZ BACKFLOW PREVENTER NOT TO SCALE

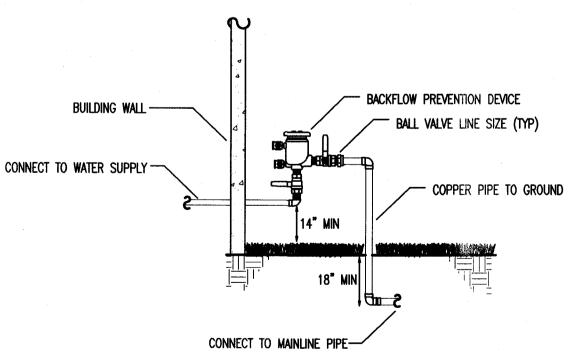

PRESSURE VACUUM

BREAKER NOT TO SCALE



JOHN DEERE LANDSCAPES

31691 DEQUINDRE RD MADISON HEIGHTS, MI 48071 PH: (248) 588-7747 FX: (248) 588-7963 WWW.JohnDeereLandscapes.com jparko@JohnDeereLandscapes.com

IA

Notes Date 02-08-10 FOR BID 02-16-10 ADDENDUM

Job No: 09060 File: 020810 evs massillon LP.dwg