
ENVIRONMENTAL REQUIREMENTS NEW PAR dba NOTICE TO CONTRACTOR ☐ NO ENVIRONMENTAL RESTRICTIONS Approved by the Massillon City Engineer verizonwireless this _____Day of **Verīzon**wireless SITE NAME: Keith A. Dylewski, P.E., P.S. MASSILLON DT II SITE NUMBER: HARPER Only approved signed plans by the City Engineer are to CNTN-056 ENGINEERING, INC. be used for construction. TELECOM GROUP 815 Superior Ave. Suite 1514 Cleveland, OH. 44114 RAW LAND MONOPOLE SITE Phone: (216)344-3855 Fax: (216)344-3856 PROJECT TEAM SITE INFORMATION SHEET INDEX LAND SPACE: 125'-0" X 75'-0" ± SHEET DESCRIPTION REV. ENGINEER: EQUIPMENT ENCLOSURE: PREFABRICATED CONCRETE 26'-0"± X 11'-6"± EQUIPMENT SHELTER HARPER ENGINEERING, INC. T- 1 TITLE SHEET 815 SUPERIOR AVE. SUITE 1514 CONSTRUCTION TYPE: VB / USE GROUP "S2" CLEVELAND, OH. 44114 GOVERNING CODE: SURVEY OBC 2011/IBC 2009 (216)344-3855 C-1 CIVIL PLAN SITE ADDRESS: FINEFROCK ROAD SM DRAWING REVISIONS SILT FENCE PLAN & DETAILS MASSILLION, OH 44647 CONTACT PERSON: COUNTY: Description: Date: STARK COUNTY CIVIL DETAILS DAVID M. HARPER 04/25/14 DMH For Approval PROPERTY OWNER: EBBROS, LLC. (216)344-3855 For Approval 07/28/14 DWH 2481 MANCHESTER AVENUE NM. SITE PLAN & ELEVATION For Construction 08/12/14 DWH NORTH LAWRENCE, OH 44666 Rev'd. Per City 01/12/15 DWH PROPERTY OWNER MAURICE "MO" EBERHARDT DO NOT SCALE DRAWINGS 5-1 FOUNDATION DETAILS CONTACT: (330)495-5365 5-2 SHELTER DETAILS ZONING JURISDICTION: CITY OF MASSILLON CONTRACTOR SHALL VERIFY ALL PLANS & EXISTING DIMENSIONS & CONDITIONS ON THE JOB SITE & TAXID NUMBER: 617852 SHALL IMMEDIATELY NOTIFY THE ARCHITECT IN TEMPORARY POWER UTILITY DETAILS WRITING OF ANY DISCREPANCIES BEFORE APPLICANT: NEW PAR dba PROCEEDING WITH THE WORK OR BE RESPONSIBL UTILITY DETAILS VERIZON MIRELESS FOR SAME 7575 COMMERCE COURT GROUNDING PLAN & RISER DIAGRAM LEMIS CENTER, OH 43035 OFFICE (614) 307-1056 E-3 GROUNDING DETAILS HANDICAP REQUIREMENTS POWER PROVIDER: FIRST ENERGY (OHIO EDISON) E-4 GROUNDING DETAILS MORK ORDER #56765812 FACILITY IS UNMANNED AND NOT FOR HUMAN NOTIFICATION #732984752 GROUNDING DETAILS HABITATION. HANDICAP ACCESS IS NOT REQUIRED CONTACT NAME: KEVIN MCCLUSKY CONTACT NUMBER (330) 830-7083 OTHER REQUIREMENTS FIBER PROVIDER: SP-1 GENERAL NOTES ACCOUNT NUMBER: - FACILITY HAS NO PLUMBING OR PARKING GENERAL NOTES CONTACT NAME: - NO GRADING WILL BE REQUIRED FOR THIS SITE. NOTICE TO CONTRACTOR CONTACT NUMBER (XXX) XXX-XXXX NTC AREA MAP VICINITY MAP NO SCALE NO SCALE Engineer's Seal SITE NAME: NORTH MASSILLON DT II NORTH SITE NUMBER: DRIVING DIRECTIONS FROM VERIZON MIRELESS CNTN-056 7575 COMMERCE COURT LEWIS CENTER, OH 43035 FINEFROCK ROAD SM MASSILLON, OH 44647 Turn left onto Orangepoint Dr. Turn left onto US-23. Griffith Ave SW Turn left onto OH-750/ E. Powell Rd. Bear right onto SHEET NAME: OH-750 E./ Polaris Pkwy. Turn left onto Gemini Pl. Take Finefrock Rd SW ramp left for I-71 North toward Cleveland. At exit 176, take ramp right for US-30 toward Mooster. Turn right onto US-30 E. Keep straight on US-30 E. Take ramp TITLE right for OH-241 toward Brewster/Massillon. Turn left onto OH-24 1/Millersburg Rd. SM. Road name changes to Finefrock Rd. SW. Site is located on the right. SHEET TOWER COORDINATES LATITUDE: N. 40° 46' 52.07" SHEET No./Rev.: N. 40.781131° SCALE: AS NOTED LONGITUDE: W. 81°31'44.91" DRWN. BY: MEP W. 81.529142° CHK'D. BY: GJB _ DATE: 11/15/13 FILE: 9-149-078 3

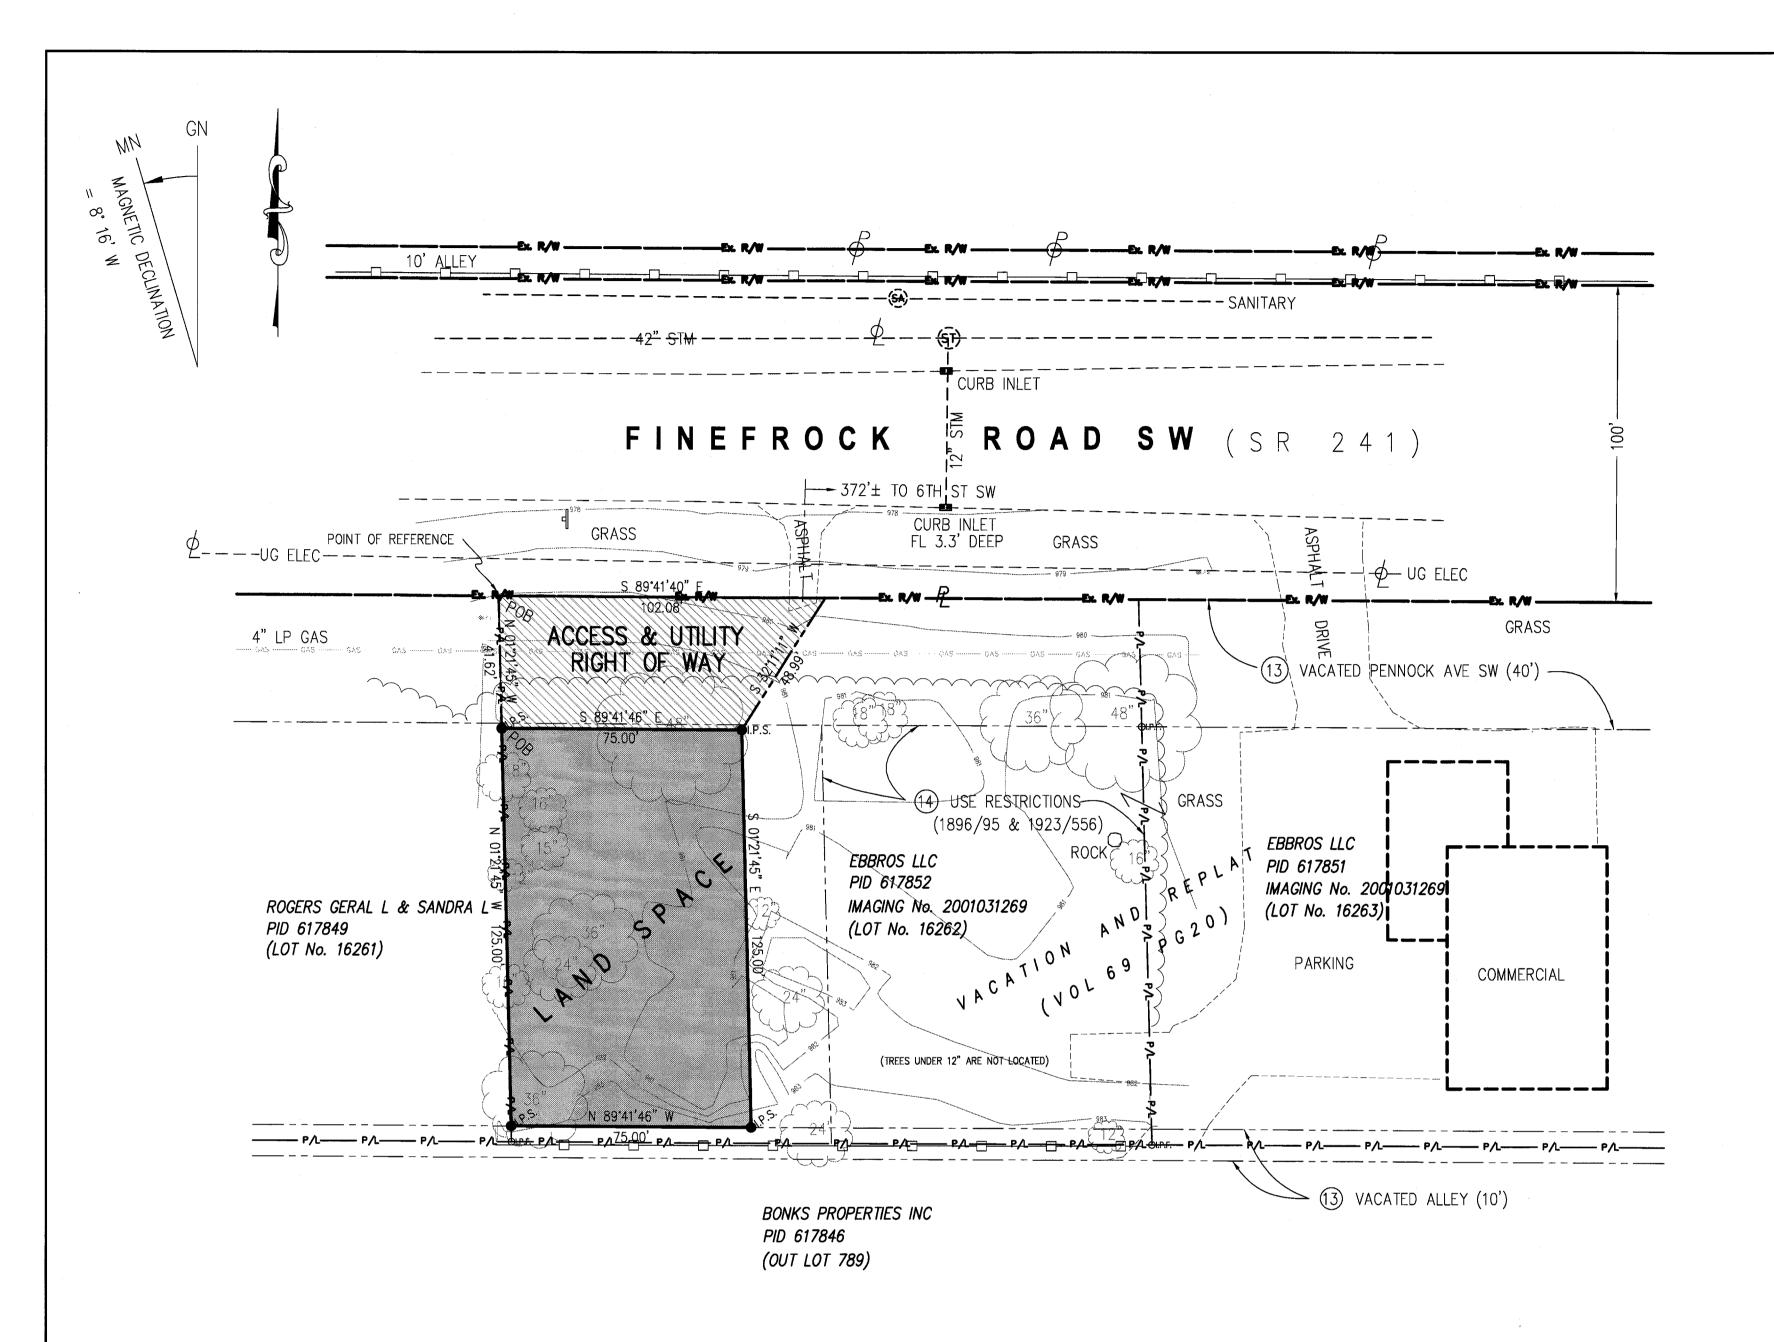

COMMITMENT No. 13-47480 Schedule B - Section 2

12. Plat Volume 65, Page 29 includes the parent parcel and more. The right of way of Finefrock Road affects the Access and Utility Right of Way. It does not affect the Land Space.

13. Plat Book 69, Page 20 includes the parent parcel and more. The vacated Pennock Ave SW (40') affects the Access and Utility Right of Way. It does not affect the Land Space. The vacated 10' alley does not affect the Land Space or the Access and utility right of Way.

14. Use restrictions, covenants and conditions in Volume 1896, Page 95, and Amendment to Restrictions in Volume 1923, Page 556 describe the east one—half of former Lot No. 15646. It does not affect the Land Space or the Access and utility right of Way

15. Oil and Gas Lease in Volume 1529, Page 345 includes the parent parcel and more. It affects the Land Space and the Access and Utility right of Way. However, there is no field evidence of any oil and gas features in or adjacent to the site.

16. Warranty Deed in Imaging No. 98085204 includes the parent parcel and more. It affects the Land Space and the Access and Utility Right of Way.

THE LAND SPACE, AS SHOWN IN THE COORDINATES BELOW, HAVE A HORIZONTAL ACCURACY WITHIN +/ 50 FEET AND A VERTICAL ACCURACY OH-750/E Powell Rd for 1.8 miles. WITHIN +/- 20 FEET.

LATITUDE: 40° 46' 52.25" N LONGITUDE: 81° 31' 45.07" W

GROUND ELEVATION: 981 FT (NAVD 88)

and turn left on Orange Point Dr. Turn left onto US-23 Columbus Pike for 1.7 miles. Turn left onto Turn left onto Gemini PI for 1.2 I toward Cleveland for 54.8 miles. Take exit 176 to merge onto US 30 toward Wooster for 45.7 miles. Take OH-241 exist toward Massillon. Turn left onto OH-241 N/Millersburg Rd for 3 miles. Arrive at site next to 651 Finefrock Rd on right.

Geiger Ave SW Griffith Ave SW Finefrock Rd SW SITE

TOWER COORDINATES

DIRECTIONS

LOCATION MAP (NOT TO SCALE)

LAND SPACE (0.215 ACRE TRACT)

Situated in the State of Ohio, County of Stark, and City of Massillon, and being part of Lot No. 16262 (formerly Lot No. 15646), conveyed to EBBROS, LLC (the Grantor), as recorded in Imaging No. 2001031269, the same as shown and numbered in Vacation and Replat recorded in Volume 69, Page 20, Stark County Recorder's Office, Ohio, and being more particularly described as

Beginning for reference at a point in the southerly right—of—way line of Finefrock Road SW (SR 241), said point being the northwest corner of said Lot No. 16262, thence S 01°21'45" E, along the west line of said Lot No. 16262 and the Grantor's west line, a distance of 41.62 feet to an iron pin set, said iron pin set being the TRUE POINT OF BEGINNING;

Thence S 89°41'46" E, a distance of 75.00 feet to an iron pin set:

Thence S 01°21'45" E, a distance of 125.00 feet to an iron pin set in the north line of a 10' vacated alley;

Thence N 89°41'46" W, along the north line of said 10' vacated alley, a distance of 75.00 feet to an iron pin set in the west line of said Lot No. 16262 and the Grantor's west line:

Thence N 01°21'45" W, along the west line of said Lot No. 16262 and the Grantor's west line, a distance of 125.00 feet to the TRUE POINT OF BEGINNING, having an area of 9371.03 Square Feet or 0.215 Acres, more or less, subject to all right—of—ways, easements and restrictions of record.

ACCESS & UTILITY RIGHT OF WAY (0.085 ACRE TRACT)

Situated in the State of Ohio, County of Stark, and City of Massillon, and being part of Lot No. 16262 (formerly Lot No. 15646), conveyed to EBBROS LLC (the Grantor), as recorded in Imaging No. 2001031269, the same as shown and numbered in Vacation and Replat recorded in Volume 69, Page 20, Stark County Recorder's Office, Ohio, and being more particularly described as

Beginning at a point in the southerly right—of—way line of Finefrock Road SW (SR 241), said point being the northwest corner of said Lot No. 16262, thence S 89°41'40" E, along the southerly right—of—way line of Finefrock Road SW, the north line of said Lot No. 16262, and the Grantor's north line, a distance of 102.08 feet to a point;

Thence S 32°11'11" W. a distance of 48.99 feet to a point, said point being the northeast corner of the Land Space;

Thence N 89°41'46" W, along the north line of the Land Space, a distance of 75.00 feet to a point in the west line of said Lot No. 16262 and the Grantor's west line:

Thence N 01°21'45" W, along the west line of said Lot No. 16262 and the Grantor's west line, a distance of 41.62 feet to the POINT OF BEGINNING, having an area of 3683.28 Square Feet or 0.085 Acres, more or less, subject to all right-of-ways, easements and restrictions of record.

LEGEND

\oint_{Γ}	POWER POLE	OI.P.F. IRON PIN FOUND OI.P.S. IRON PIN SET
ϕ	LIGHT POLE	●P.K.S. PK NAIL SET
$\bar{\overline{\phi}}$	TELEPHONE POLE	●M.N.S. MAG NAIL SET MONU — MONUMENT
	TELEPHONE BOX	IP - IRON PIN
Œ	ELECTRIC BOX	POB — POINT OF BEGINNING
		- CENTERLINE
		- RIGHT OF WAY LINE
—— Р/L:	Р/L Р/L Р/L	- PROPERTY LINE
-		- LAND SPACE
		- PROPOSED RIGHTS OF WAY
		- EXISTING EASEMENT
		- FENCE

EASEMENTS AND RECORDING INFORMATION SHOWN HEREON ARE BASED ON TITLE REPORT (COMMIMENT No. 13-47480), PROVIDED TO PS SURVEYING & MAPPING GROUP, LLC BY AGENTS OF NEW PAR, d.b.a. VERIZON WIRELESS. ALL VISIBLE EVIDENCE OF UTILITIES OR OTHER DATA OBSERVED IN THE FIELD IS DELINEATED HEREON.

TO NEW PAR. d.b.a. VERIZON WIRELESS: THIS IS TO CERTIFY THAT THIS MAP OR PLAT AND THE SURVEY ON WHICH IT WAS MADE IS IN ACCORDANCE WITH THE "MINIMUM STANDARD DETAIL REQUIREMENTS FOR ALTA/ASCM LAND TITLE SURVEYS", JOINTLY ESTABLISHED AND ADOPTED BY ALTA AND ASCM IN 1992. HOWEVER, THE FOCUS OF THIS SURVEY IS THE LAND SPACE AND RIGHTS OF WAY PERTINENT THEREUNTO. INFORMATION REGARDING PARTS OF THE SUBJECT TRACT NOT CONCERNED WITH SAID LAND SPACE AND THE SPECIFIED RIGHTS OF WAY MAY NOT BE INCLUDED HEREON.

DATE

1/5/2015



9 | 1/5/15 | ADDRESSED CITY'S COMMENTS

4 2/25/14 REDUCED LAND SPACE TO 100' X 95'

2 12/24/13 MOVED LAND SPACE TO SW CORNER

DESCRIPTION REVISIONS

7 7/13/14 PRELIM SURVEY WITH TITLE

3 1/19/14 PRELIM SURVEY WITH TITLE

6 7/10/14 CHANGED LAND SPACE

1 | 11/19/13 | PRELIMINARY SURVEY

8 7/15/14 FINAL SURVEY

5 3/6/14 FINAL SURVEY

NO. DATE

MASSILLON DT II (CNTN-056) EBBROS LLC

STATE OF OHIO, COUNTY OF STARK, CITY OF MASSILLON FINEFROCK ROAD SW, MASSILLON, OH 44647

PREPARED FOR

NEW PAR dba VERIZON WIRELESS

PREPARED BY


PS SURVEYING & MAPPING GROUP, LLC 1425 PENTLAND PLACE, COLUMBUS, OH 43235 TEL: (614)436-2949

FINAL	. SITE SURVEY		1 OF
PS PROJECT No.	DRAWN BY	DATE	Or
13-101-30	ALC	11-19-2013	1

SURVEYOR'S NOTE:


THERE ARE NO COUNTY DITCH EASEMENTS UNDER ORC 6137.12 WHICH WOULD AFFECT THE SUBJECT LAND SPACE, AND THE SUBJECT ACCESS AND UTILITY RIGHT OF WAY. NO DITCH PLOTTED HEREON IS INVOLVED IN A COUNTY DITCH MAINTENANCE PROGRAM.

UTILITIES SHOWN IN THIS MAP ARE BASED ON VISIBLE FIELD EVIDENCE, OUPS PHYSICAL MARKINGS, OR AVAILABLE INFORMATION FROM UTILITY OWNERS. THE LOCATIONS OF ANY UNDERGROUND UTILITIES ARE ONLY APPROXIMATE. UTILITIES CONTAINED IN THIS MAP MAY NOT REPRESENT ALL THE UTILITIES IN THIS AREA.

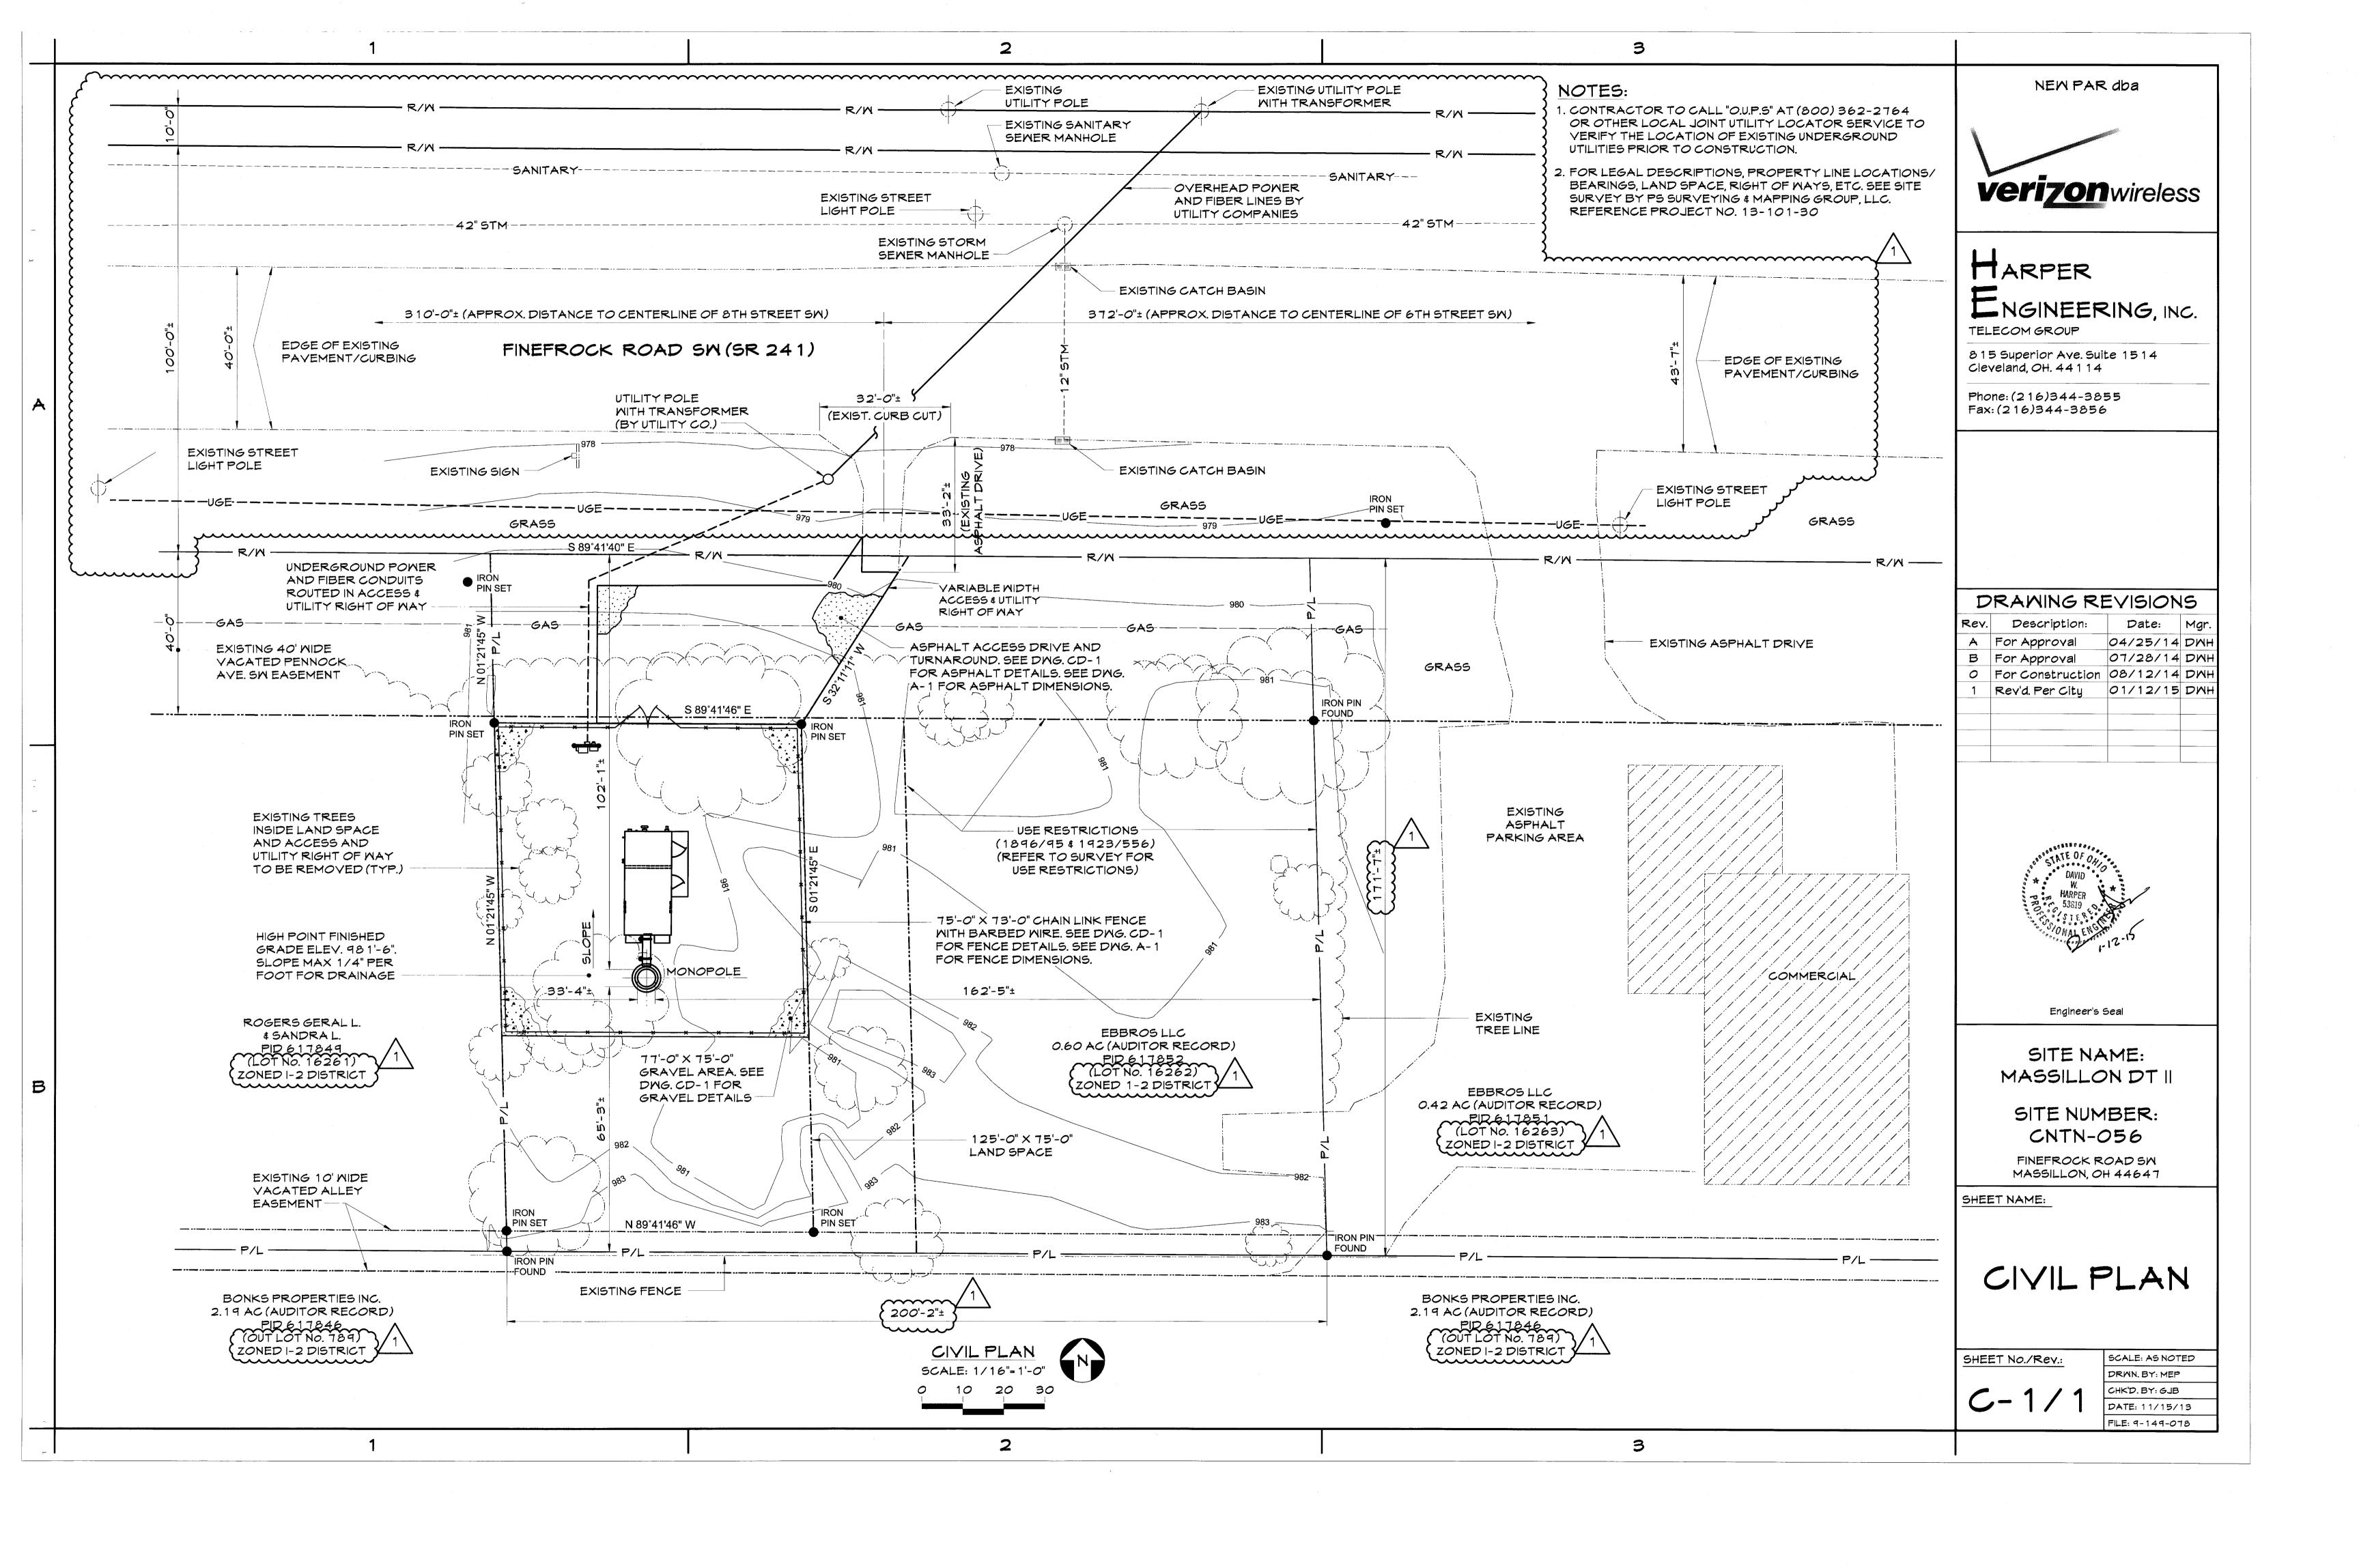

NOTES:

- 1. CONTRACTOR TO CALL "O.U.P.S" AT (800) 362-2764 OR OTHER LOCAL JOINT UTILITY LOCATOR SERVICE TO VERIFY THE LOCATION OF EXISTING UNDERGROUND UTILITIES PRIOR TO CONSTRUCTION.
- 2. FOR LEGAL DESCRIPTIONS, PROPERTY LINE LOCATIONS/ BEARINGS, LAND SPACE, RIGHT OF WAYS, ETC. SEE SITE SURVEY BY PS SURVEYING & MAPPING GROUP, LLC. REFERENCE PROJECT NO. 13-101-30

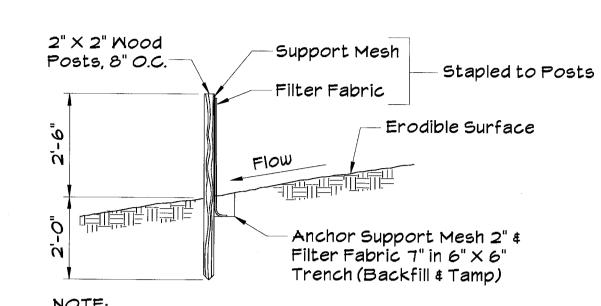

NOTE: Silt Fence to be Mirafi Envirofence or Equal SILT FENCE DETAIL SCALE: NTS

EROSION & SEDIMENT CONTROL NARRATIVE

- 1. Additional erosion control measures will be employed where determined necessary by actual site conditions.
- 2. Prior to commencing land disturbance activity, the limits of land disturbance shall be clearly and accurately demarcated with stakes, ribbons, or other appropriate means.
- 3. The construction of the site will initiate with the installation of erosion control measures sufficient to control sediment deposits and erosion. Contractor shall call local municipal representative for an inspection of soil erosion control measures prior to beginning grading activity. All sediment control will be maintained until all upstream ground within the construction area has been completely stabilized.
- 4. The location of some of the erosion control devices may have to be altered from that shown on the plans if drainage patterns during construction area differ from the final proposed drainage patterns. Any difficulty in controlling erosion during any phase of construction shall be reported to the engineer immediately. 5. Erosion control measures will be maintained at all times. If full implementation of the
- approved plan does not provide for elective erosion control, additional erosion and sediment control measures shall be implemented to control or treat the sediment source. 6. The contractor shall remove accumulated silt when the silt is within 12" of the top of the
- silt fence. 7. Failure to install, operate or maintain all erosion control measures will result in all
- construction being stopped on the job site until such measures are corrected. 8. Silt barriers to be placed at downstream toe of all cut and fill slopes.
- 9. Any disturbed areas left exposed for a period greater than 7 days shall be stabilized with seeding.
- 10. Seedina:
 - Seedbed preparation: Area to be seeded shall be loose and friable to a depth of at least 3". The top layer shall be loosened by raking, disking or other acceptable means before seeding occurs. In lieu of soil test results apply 50 lbs. of dolomitic limestone and 25 lbs. of 10-10-10 fertilizer per 1,000 sq. ft. Harrow (or disk) lime and fertilizer into the soil to a depth of at least 3" on slopes flatter than 3:1.

Seeding: Apply 50 lbs per acre of common bermuda & winter rye. Apply seed uniformly with a cyclone seeded drill cultipacker seeder or hydroseeder (slurry includes seeds and fertilizer recommended on steep slopes only) on a moist, firm base. Maximum seed depth should be 1/2" in clay soils and 1/2" in sandy soils when using other than the hydroseeder method. Irrigate until vegetation is firmly established if soil moisture is not sufficient to support adequate growth.

- 11. Contractor shall remove all erosion & sediment control measures after completion or construction and establishment of permanent ground cover.
- 12. The escape of sediment from the site shall be prevented by the installation of erosion control measures and practices prior to, or concurrent with, land-disturbing activities.
- 13. All cut and fill slopes must be surface roughened and vegetated within seven (7) days of their construction.
- 14. Control measures will be checked daily and any deficiencies noted will be corrected by the end of each day. Additional erosion and sediment control measures will be installed if deemed necessary after on-site inspection by the issuing authority.
- 15. The only materials to be buried on-site is vegetative material. Construction waste may neither be burned nor buried and must be taken to a state approved landfill.

NEW PAR dba



MARPER ENGINEERING, INC. TELECOM GROUP

815 Superior Ave. Suite 1514 Cleveland, OH. 44114

Phone: (216)344-3855 Fax: (216)344-3856

DRAWING REVISIONS

1,701.	D 0301 1Pt/011.	Date:	mgi.
0	For Construction	01/12/15	DMH
			, , , , , , , , , , , , , , , , , , , ,



Engineer's Seal

SITE NAME: MASSILLON DT II

SITE NUMBER: CNTN-056

FINEFROCK ROAD SM MASSILLON, OH 44647

SHEET NAME:

SILT FENCE PLAN AND DETAILS

SHEET No./Rev.:

DRWN. BY: MEP CHK'D. BY: GJB DATE: 11/15/13

SCALE: AS NOTED

FILE: 9-149-078

CIVIL PLAN

FINEFROCK ROAD SM (SR 241)

EXISTING ASPHALT

75'-0" X 73'-0"

CHAIN LINK FENCE

MITH BARBED MIRE

ACCESS DRIVE

UTILITY POLE

EXISTING SIGN

EXISTING TREES

INSIDE LAND SPACE

UTILITY RIGHT OF MAY

HIGH POINT FINISHED

GRADE ELEV. 981'-6".

SLOPE MAX 1/4" PER

FOOT FOR DRAINAGE

TO BE REMOVED (TYP.)

AND ACCESS AND

(BY UTILITY CO.)

AND TURNAROUND

WITH TRANSFORMER

ASPHALT ACCESS DRIVE

77'-0" X 75'-0"

GRAVEL AREA

EXISTING FENCE

SOIL DISTURBANCES

ASPHALT ACCESS DRIVE 2143.87 SQ. FT. 0.049 ACRES GRAVEL COMPOUND AREA 5775.02 SQ. FT. 0.132 ACRES


TOTAL AREA 7918.89 SQ. FT. 0.181 ACRES


EXISTING


ASPHALT


PARKING AREA


GRASS

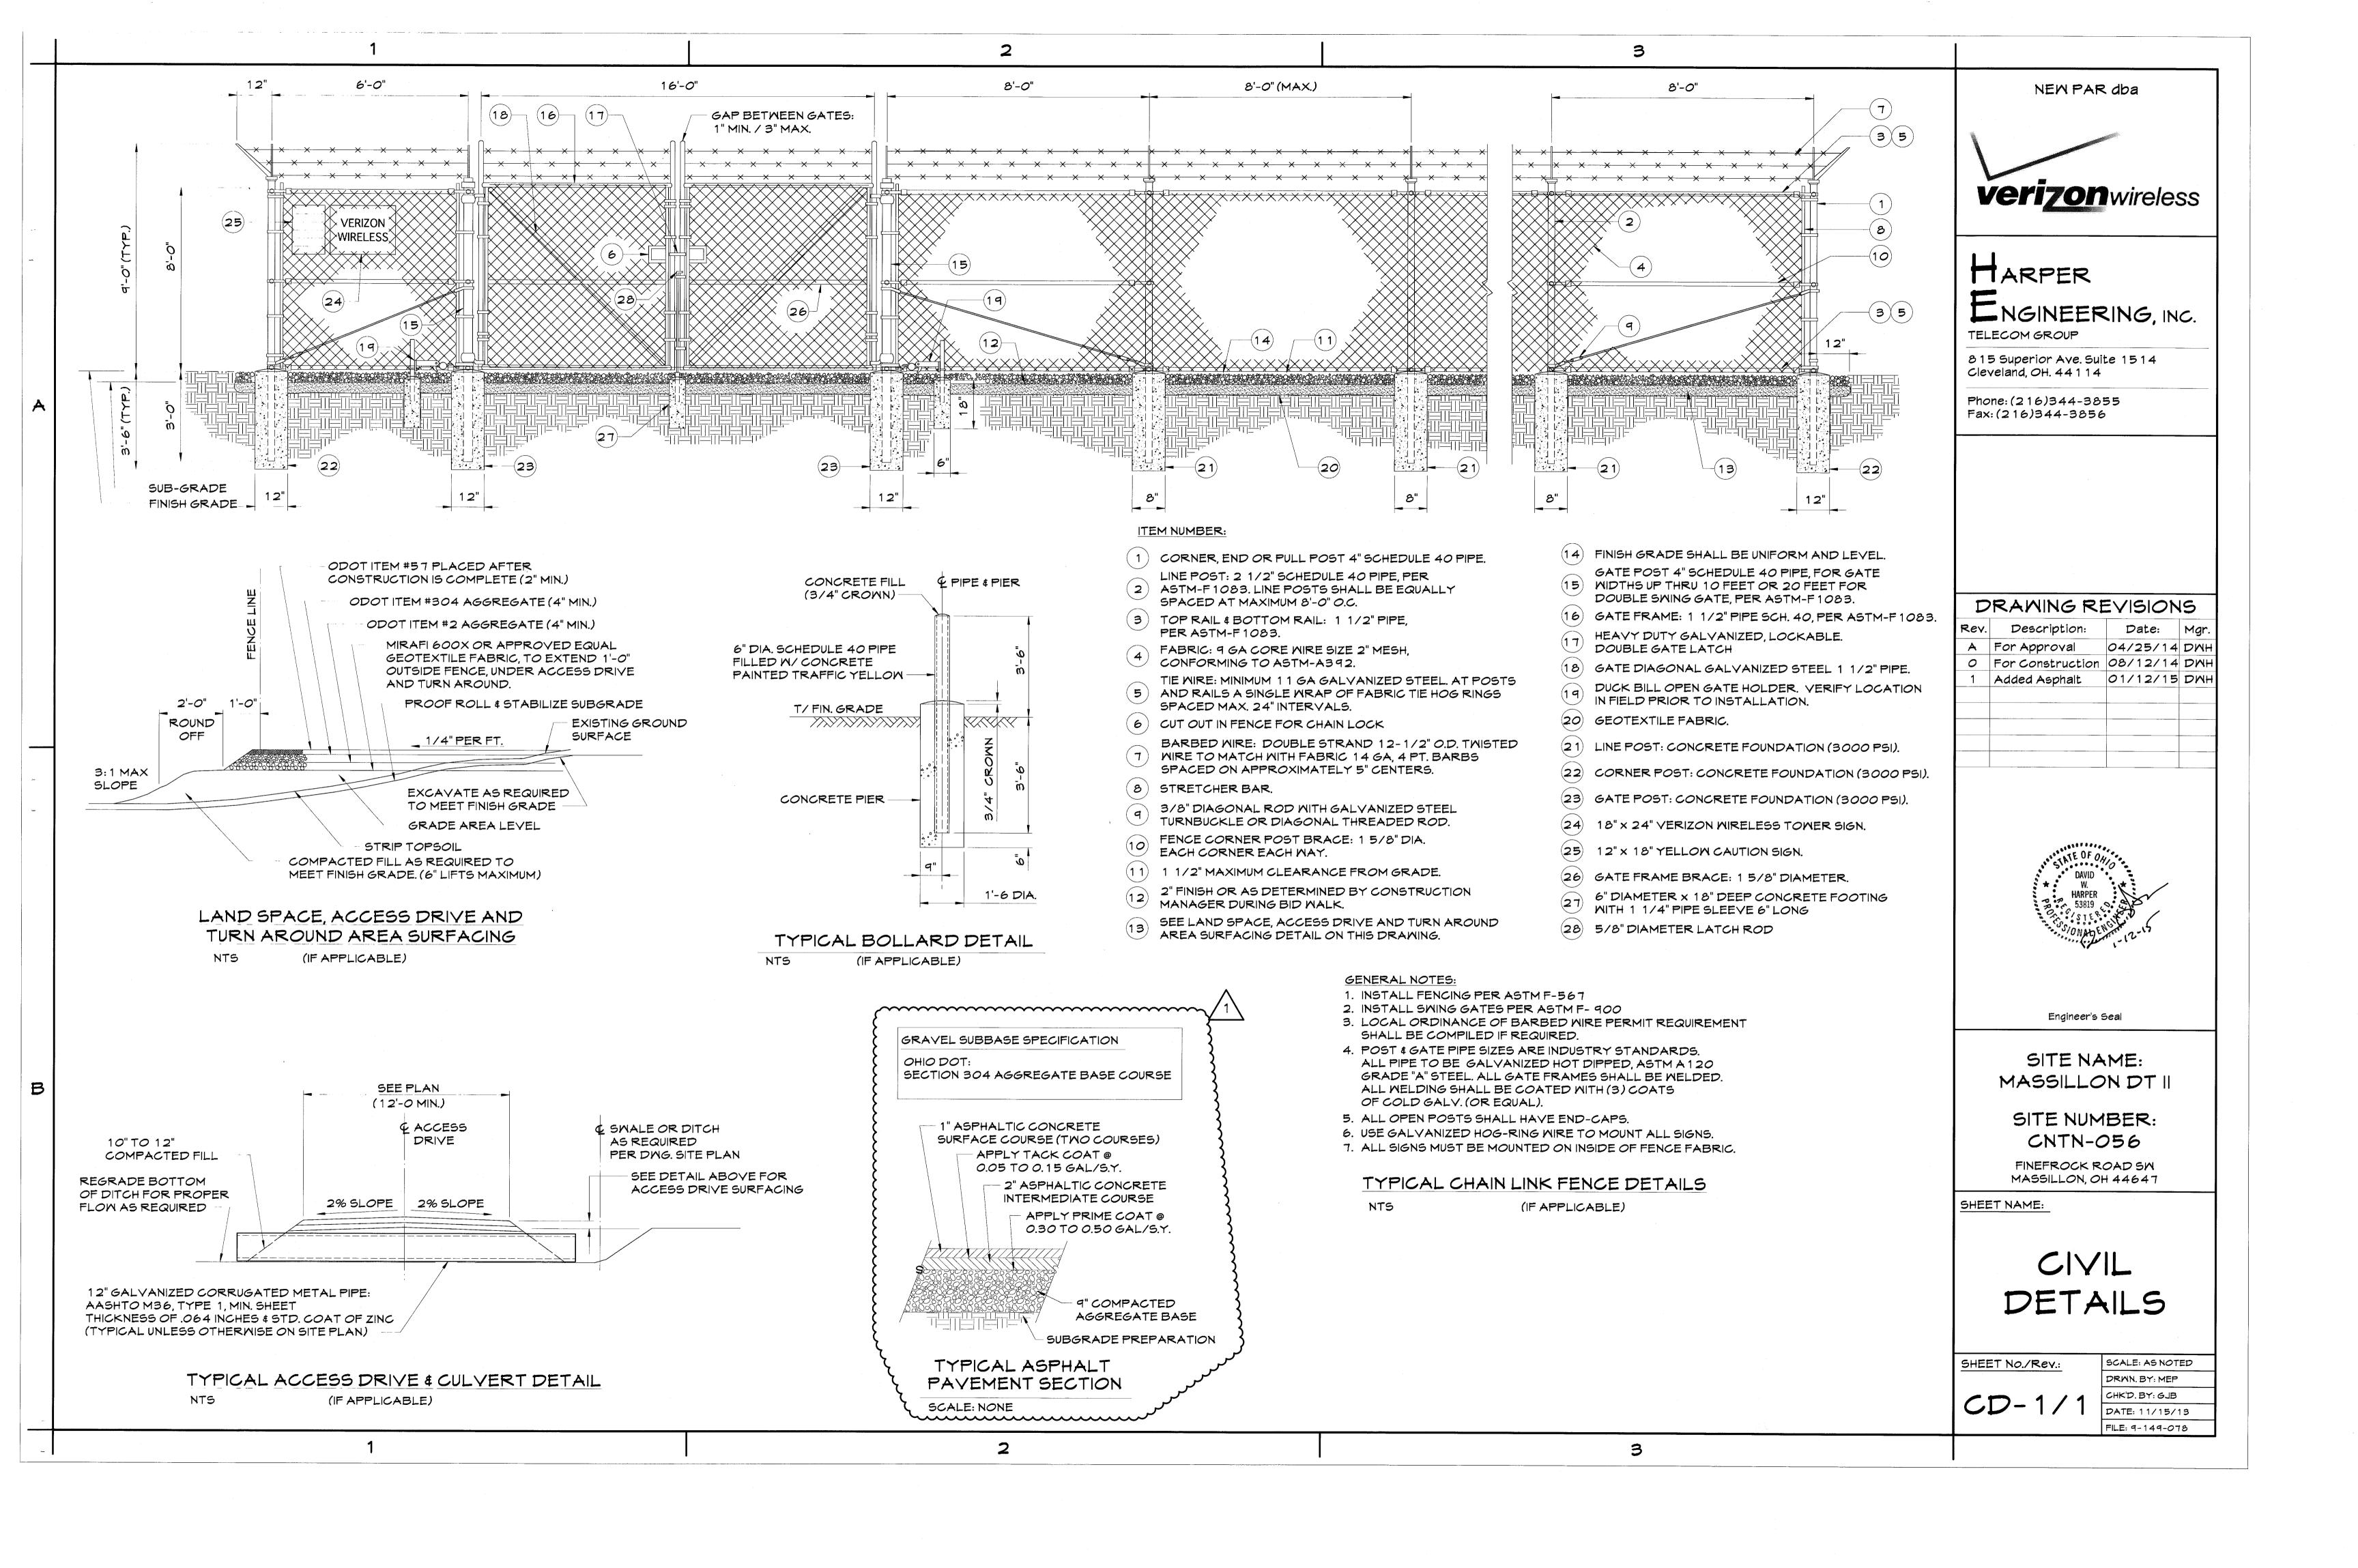


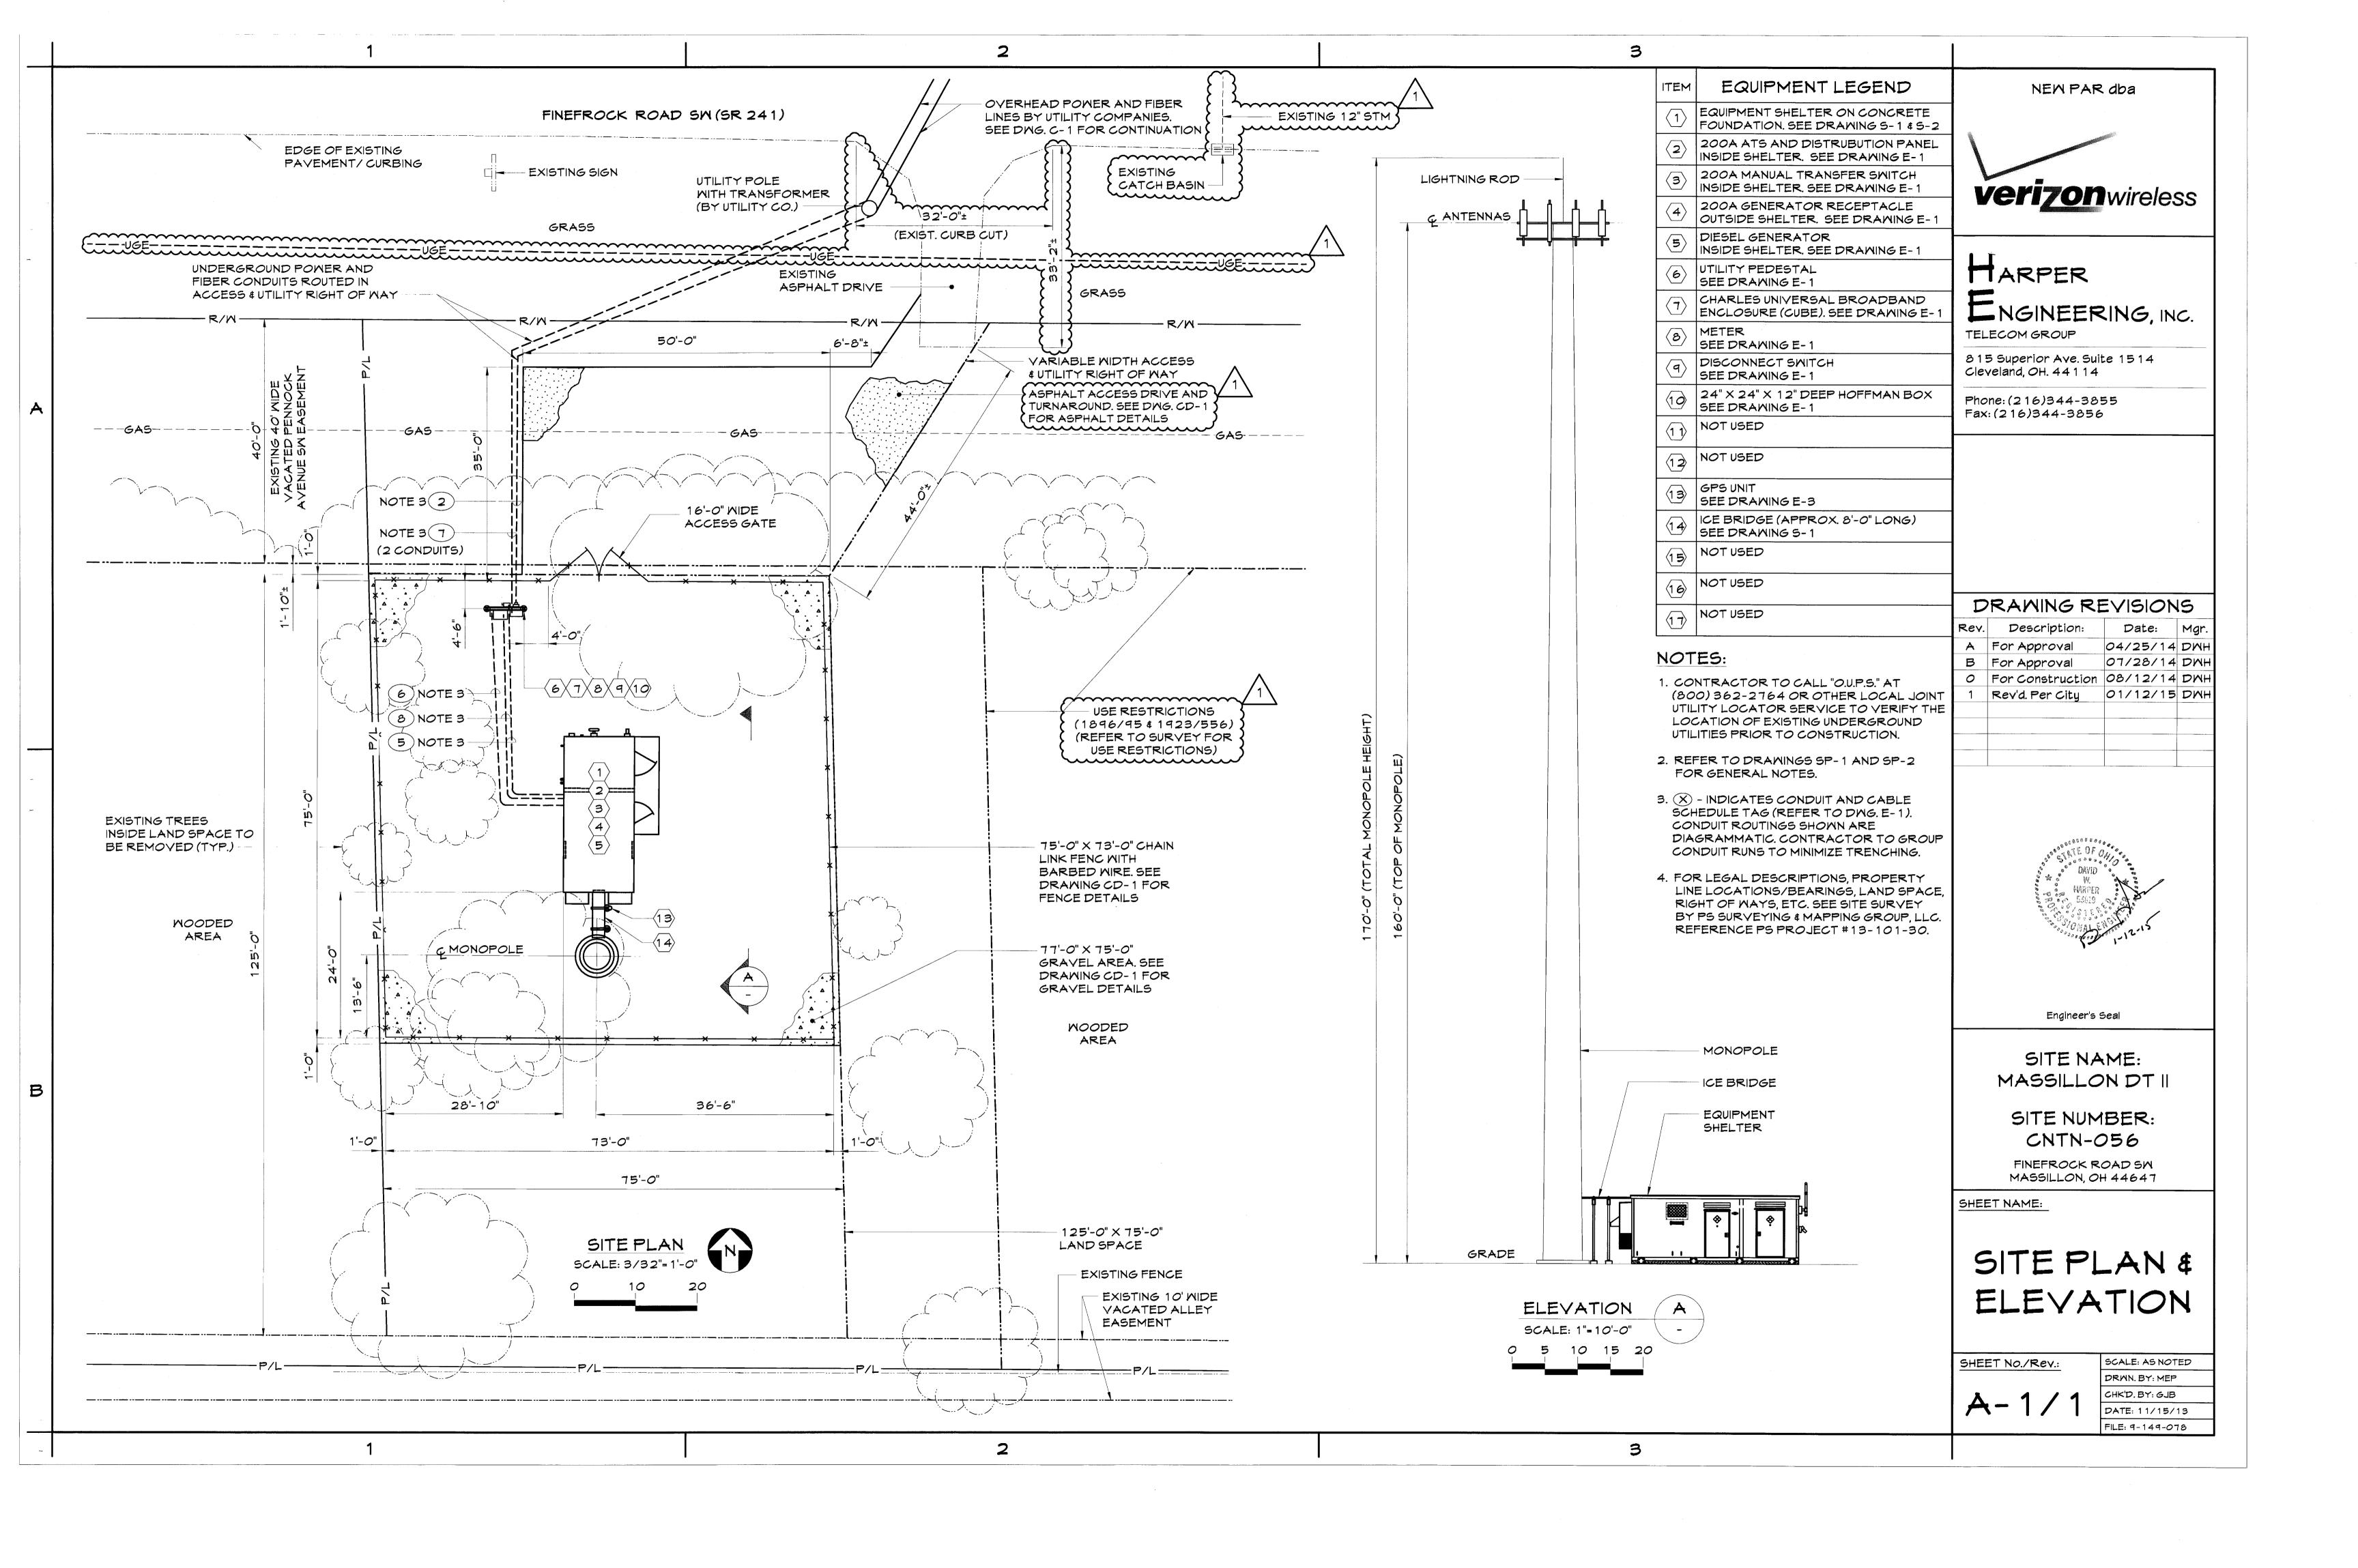


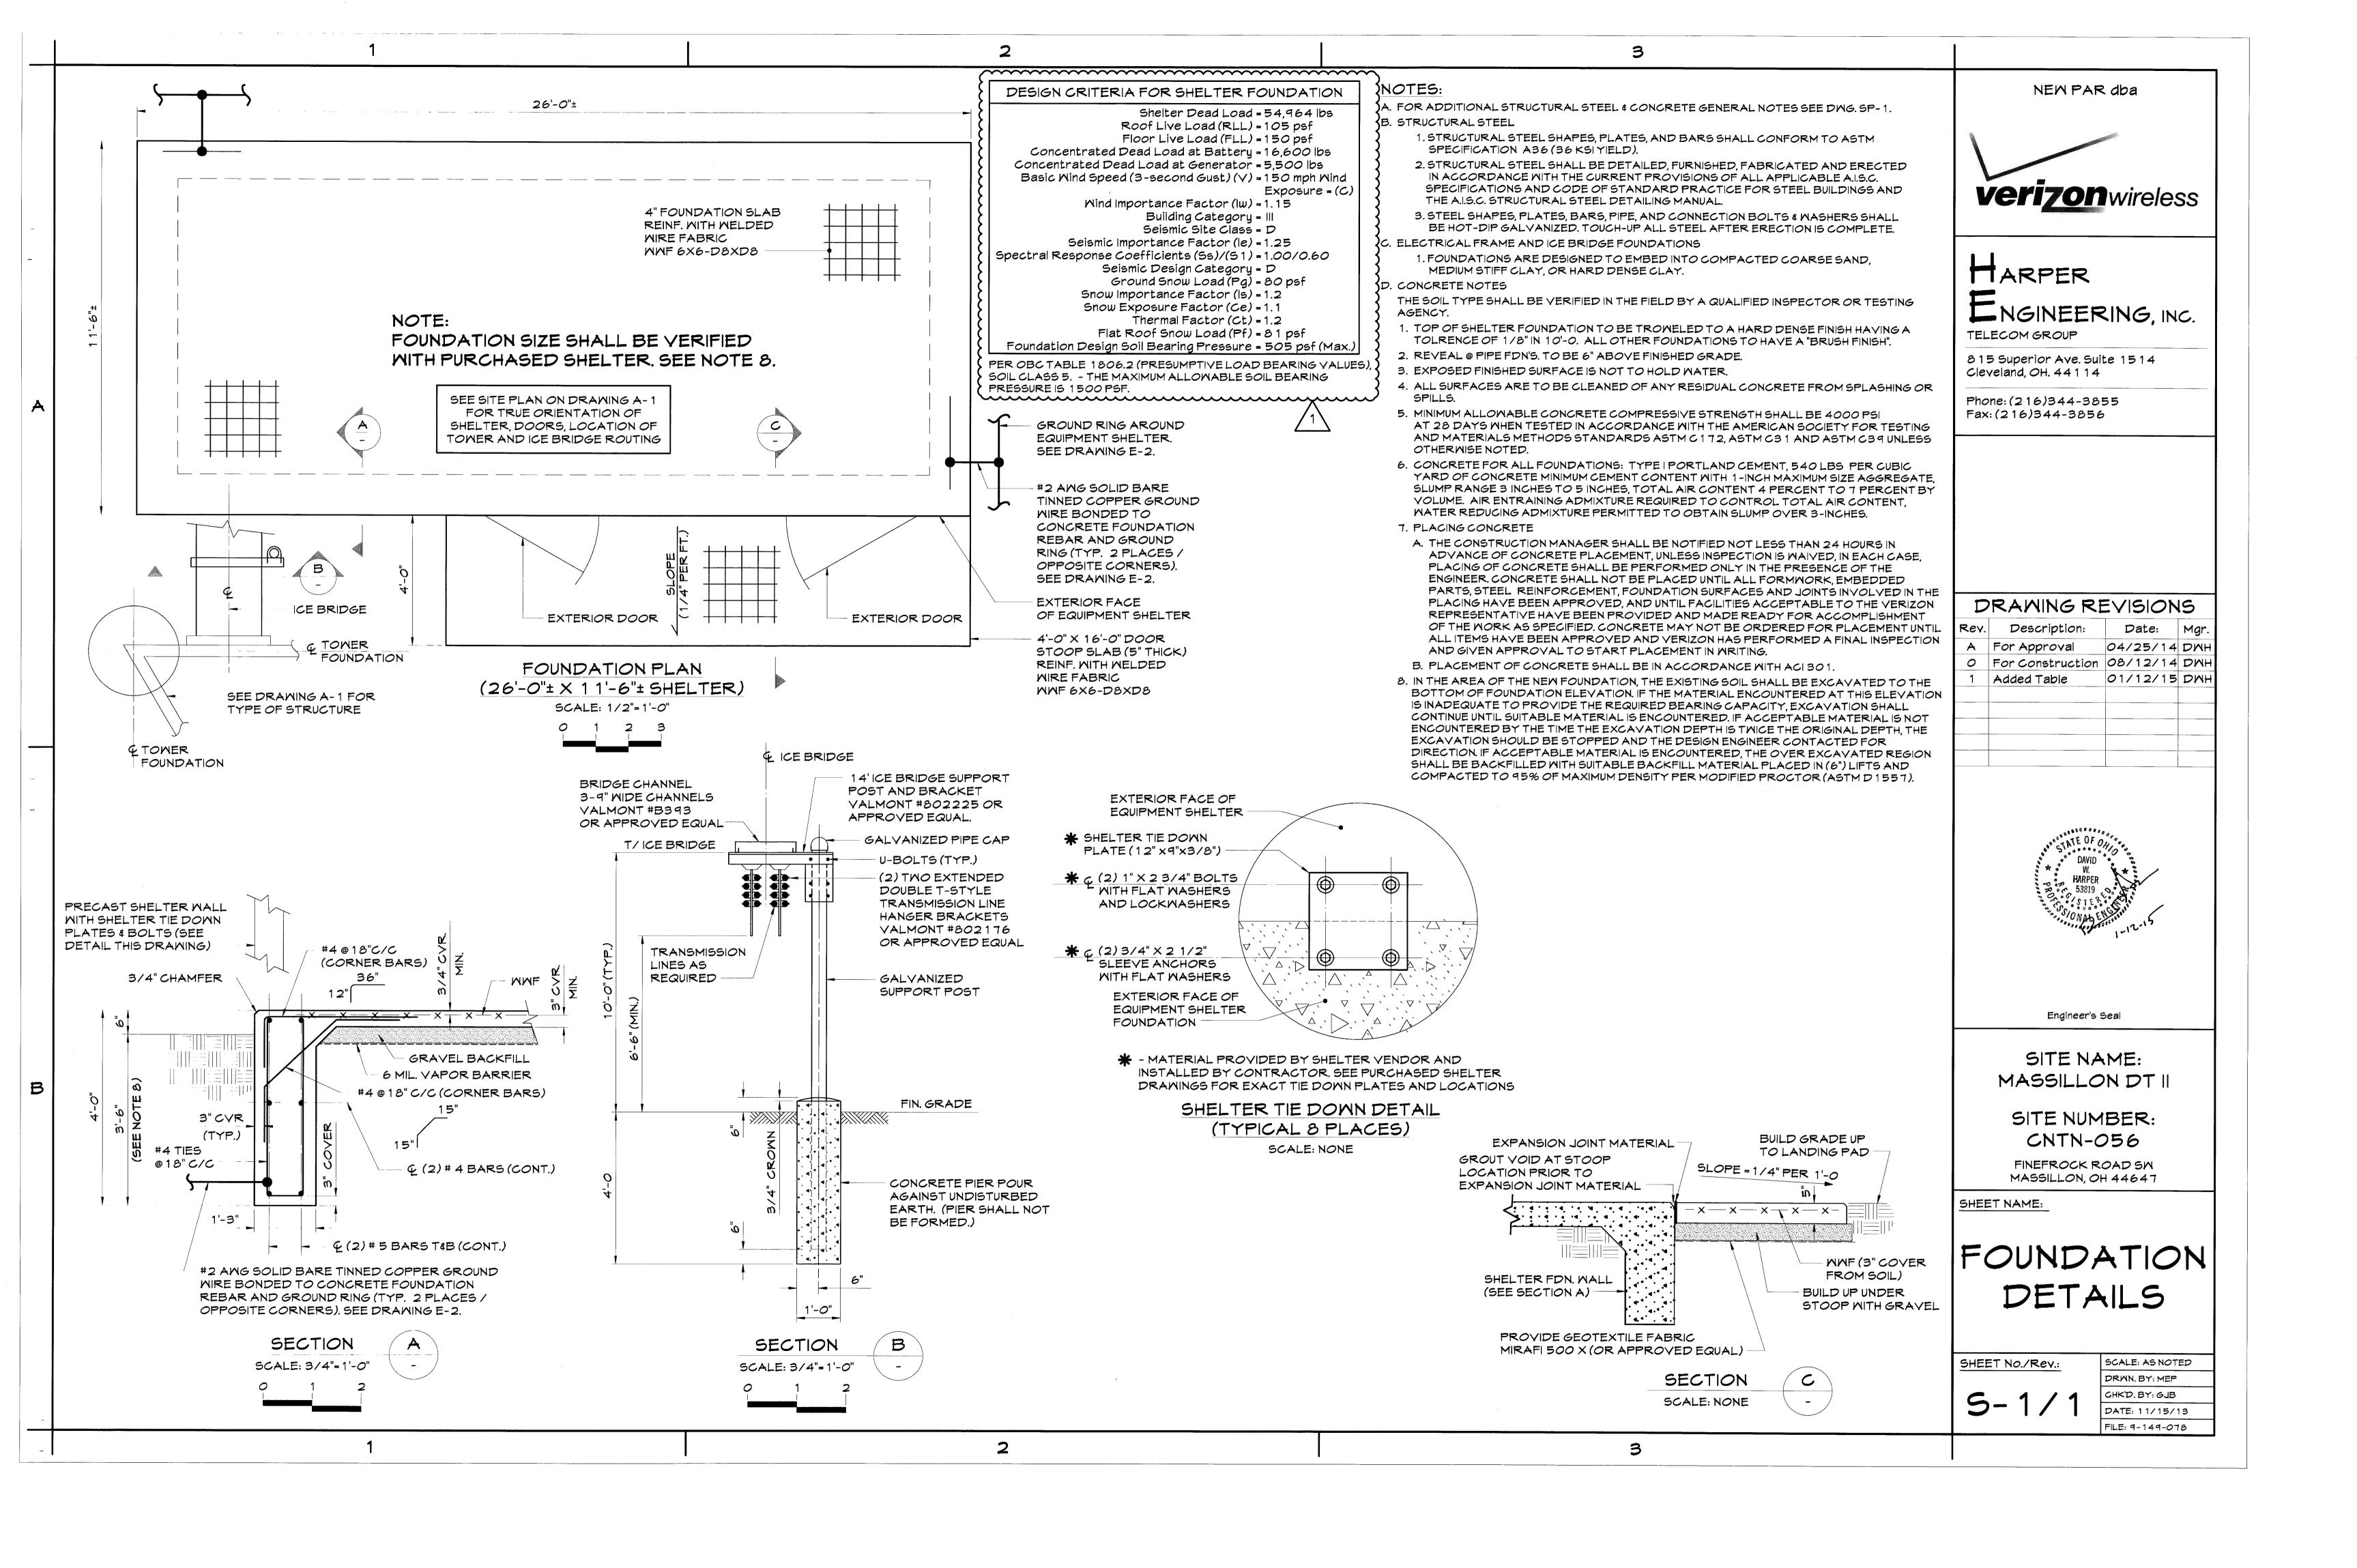

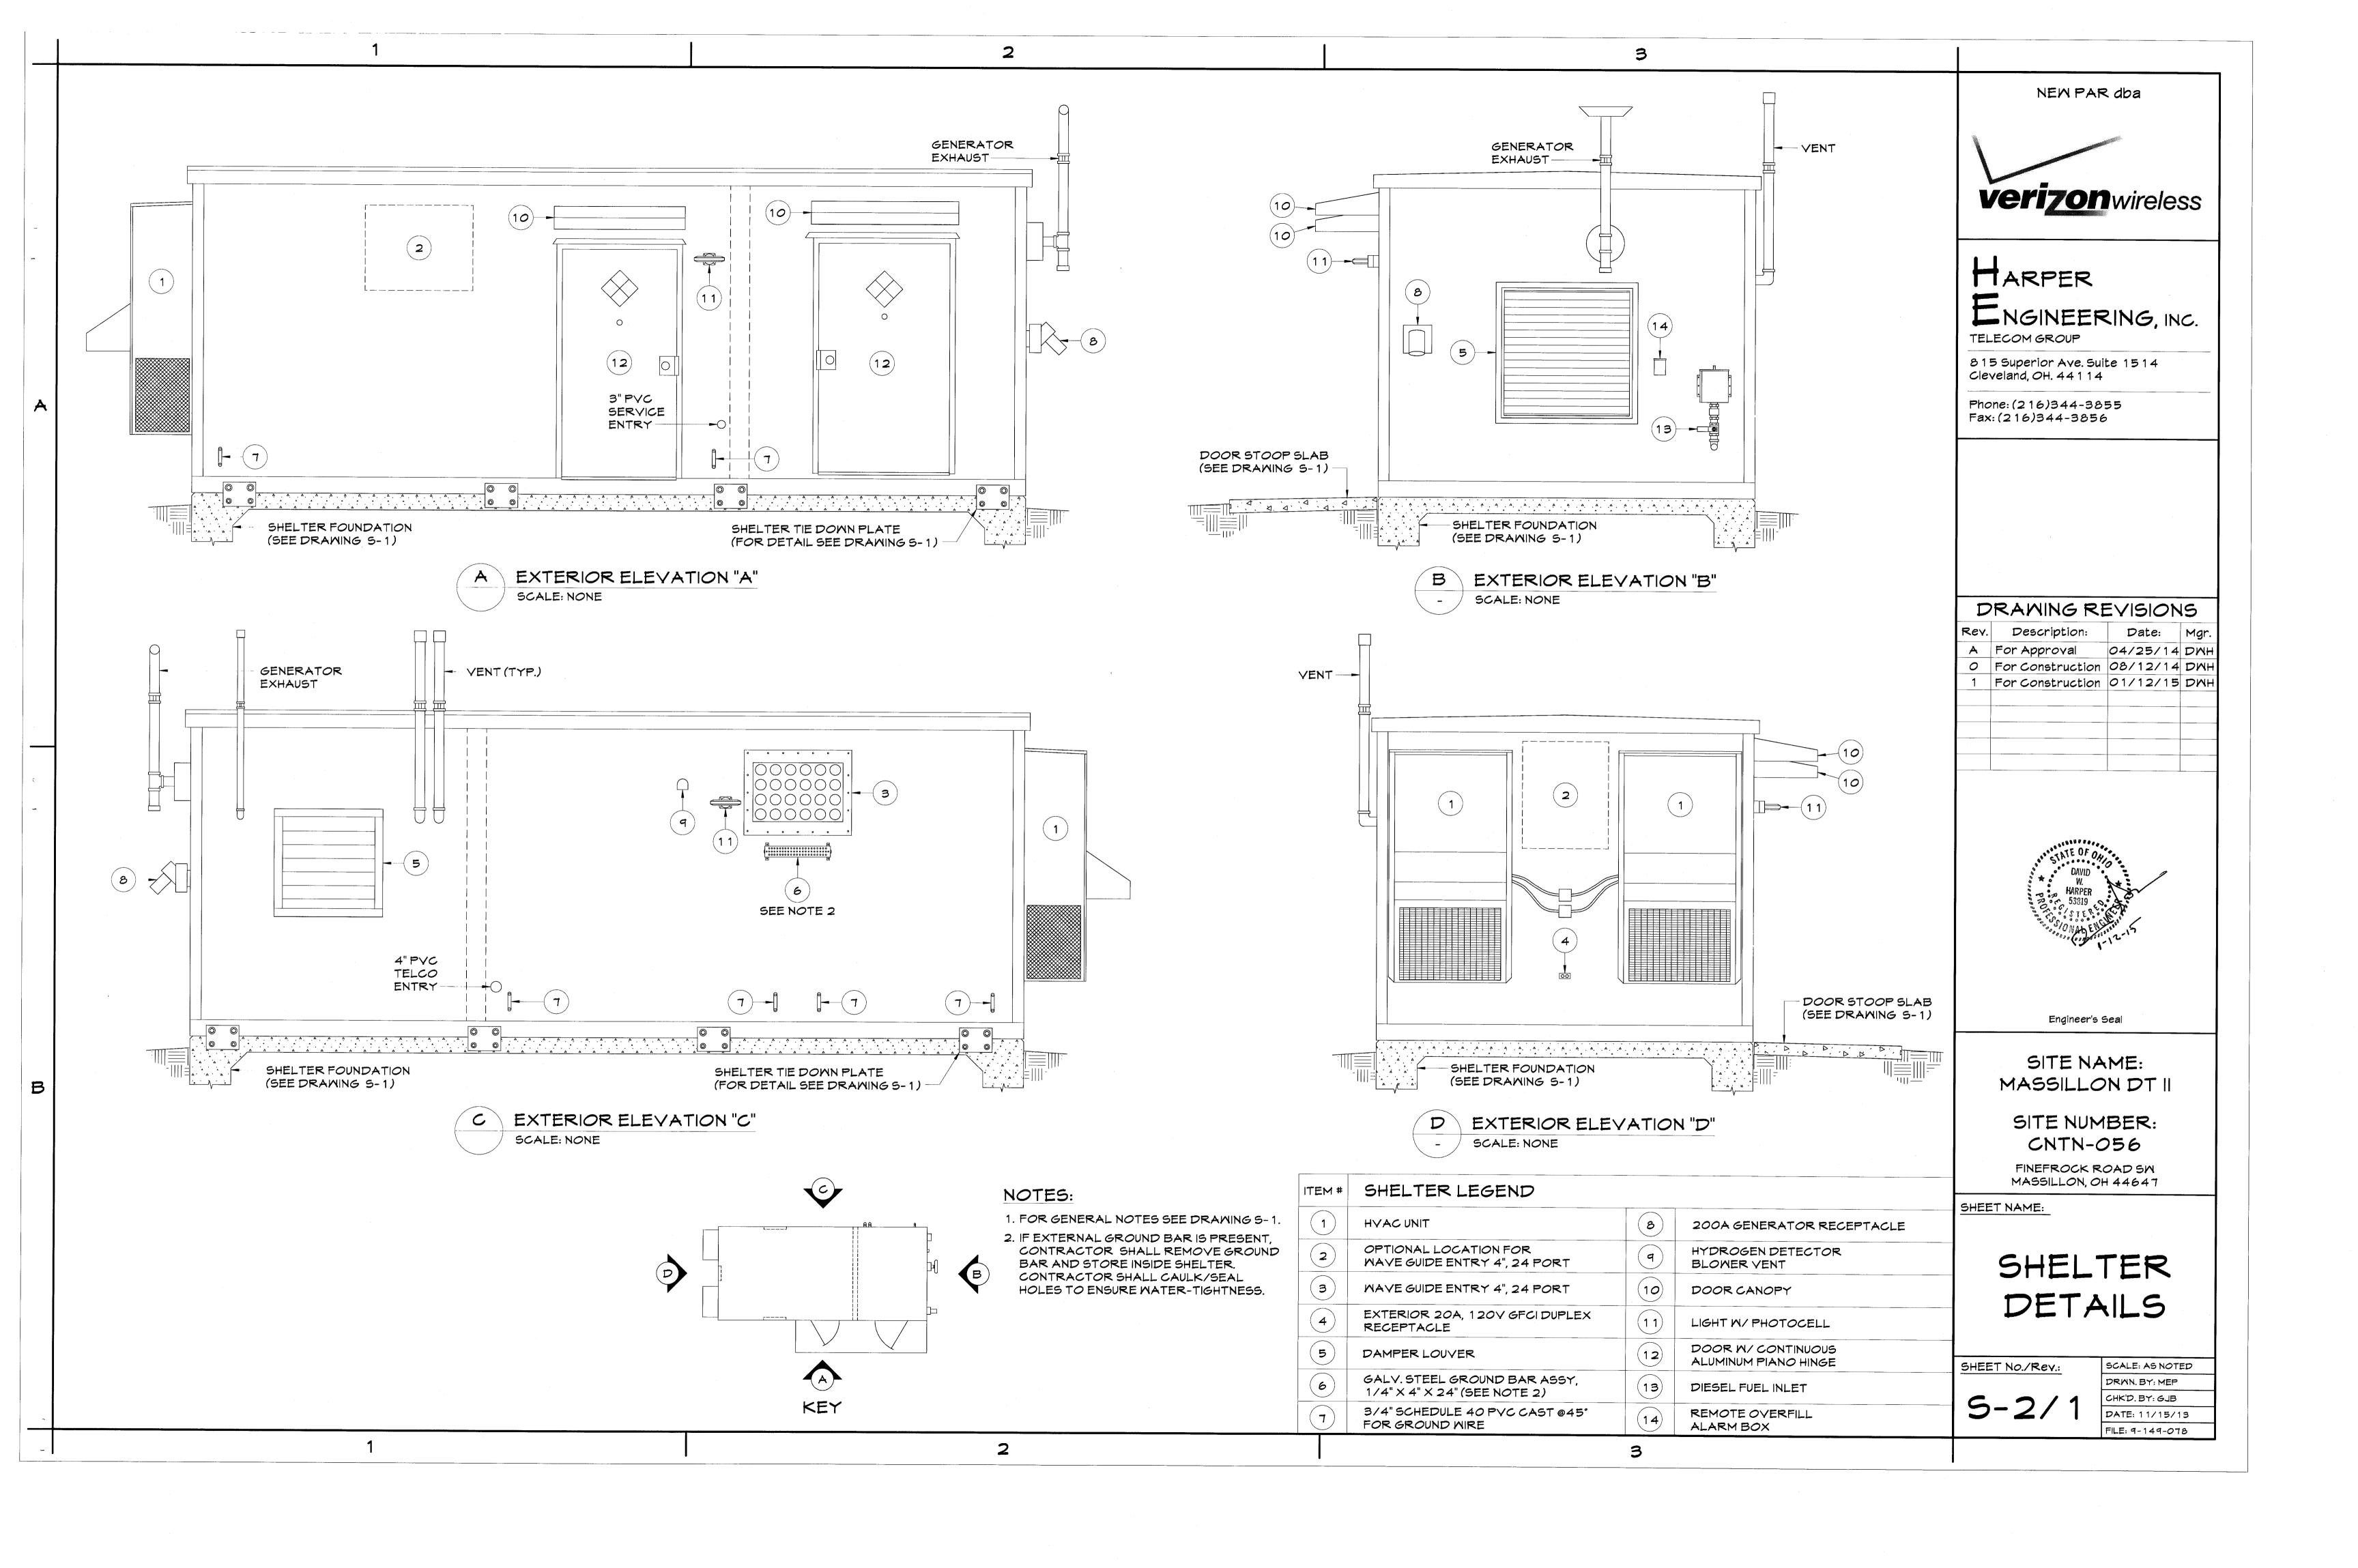


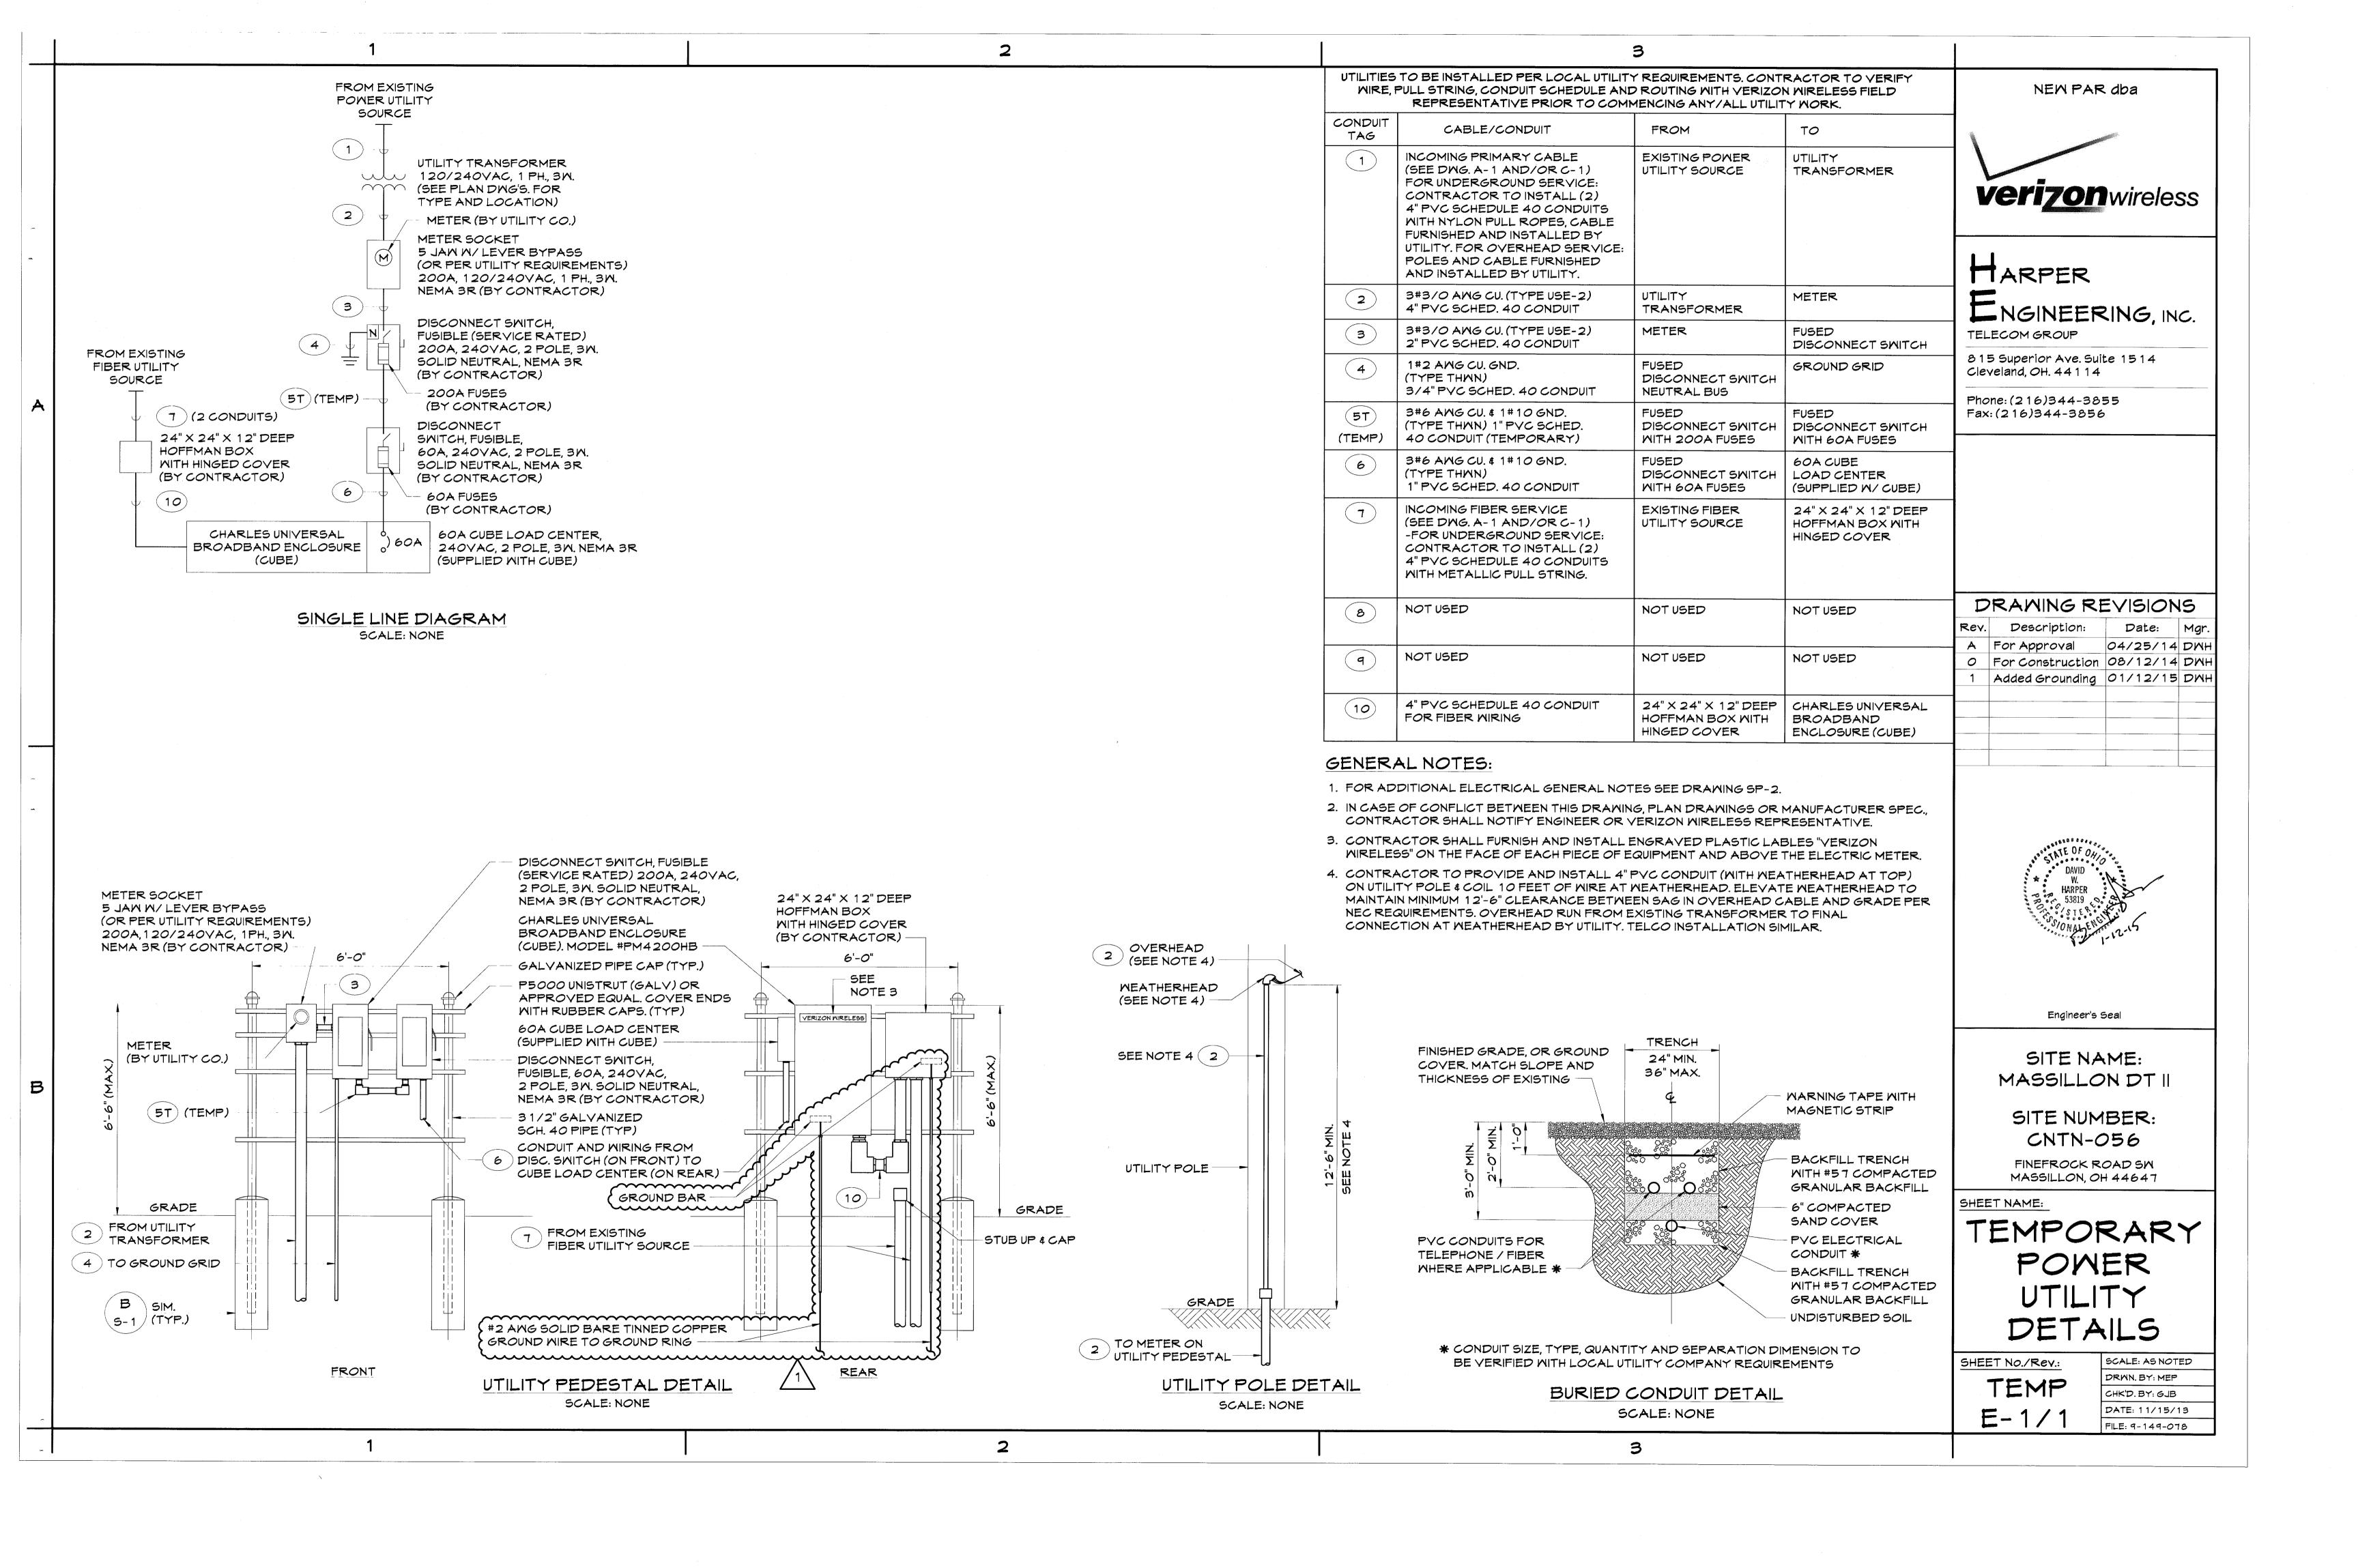

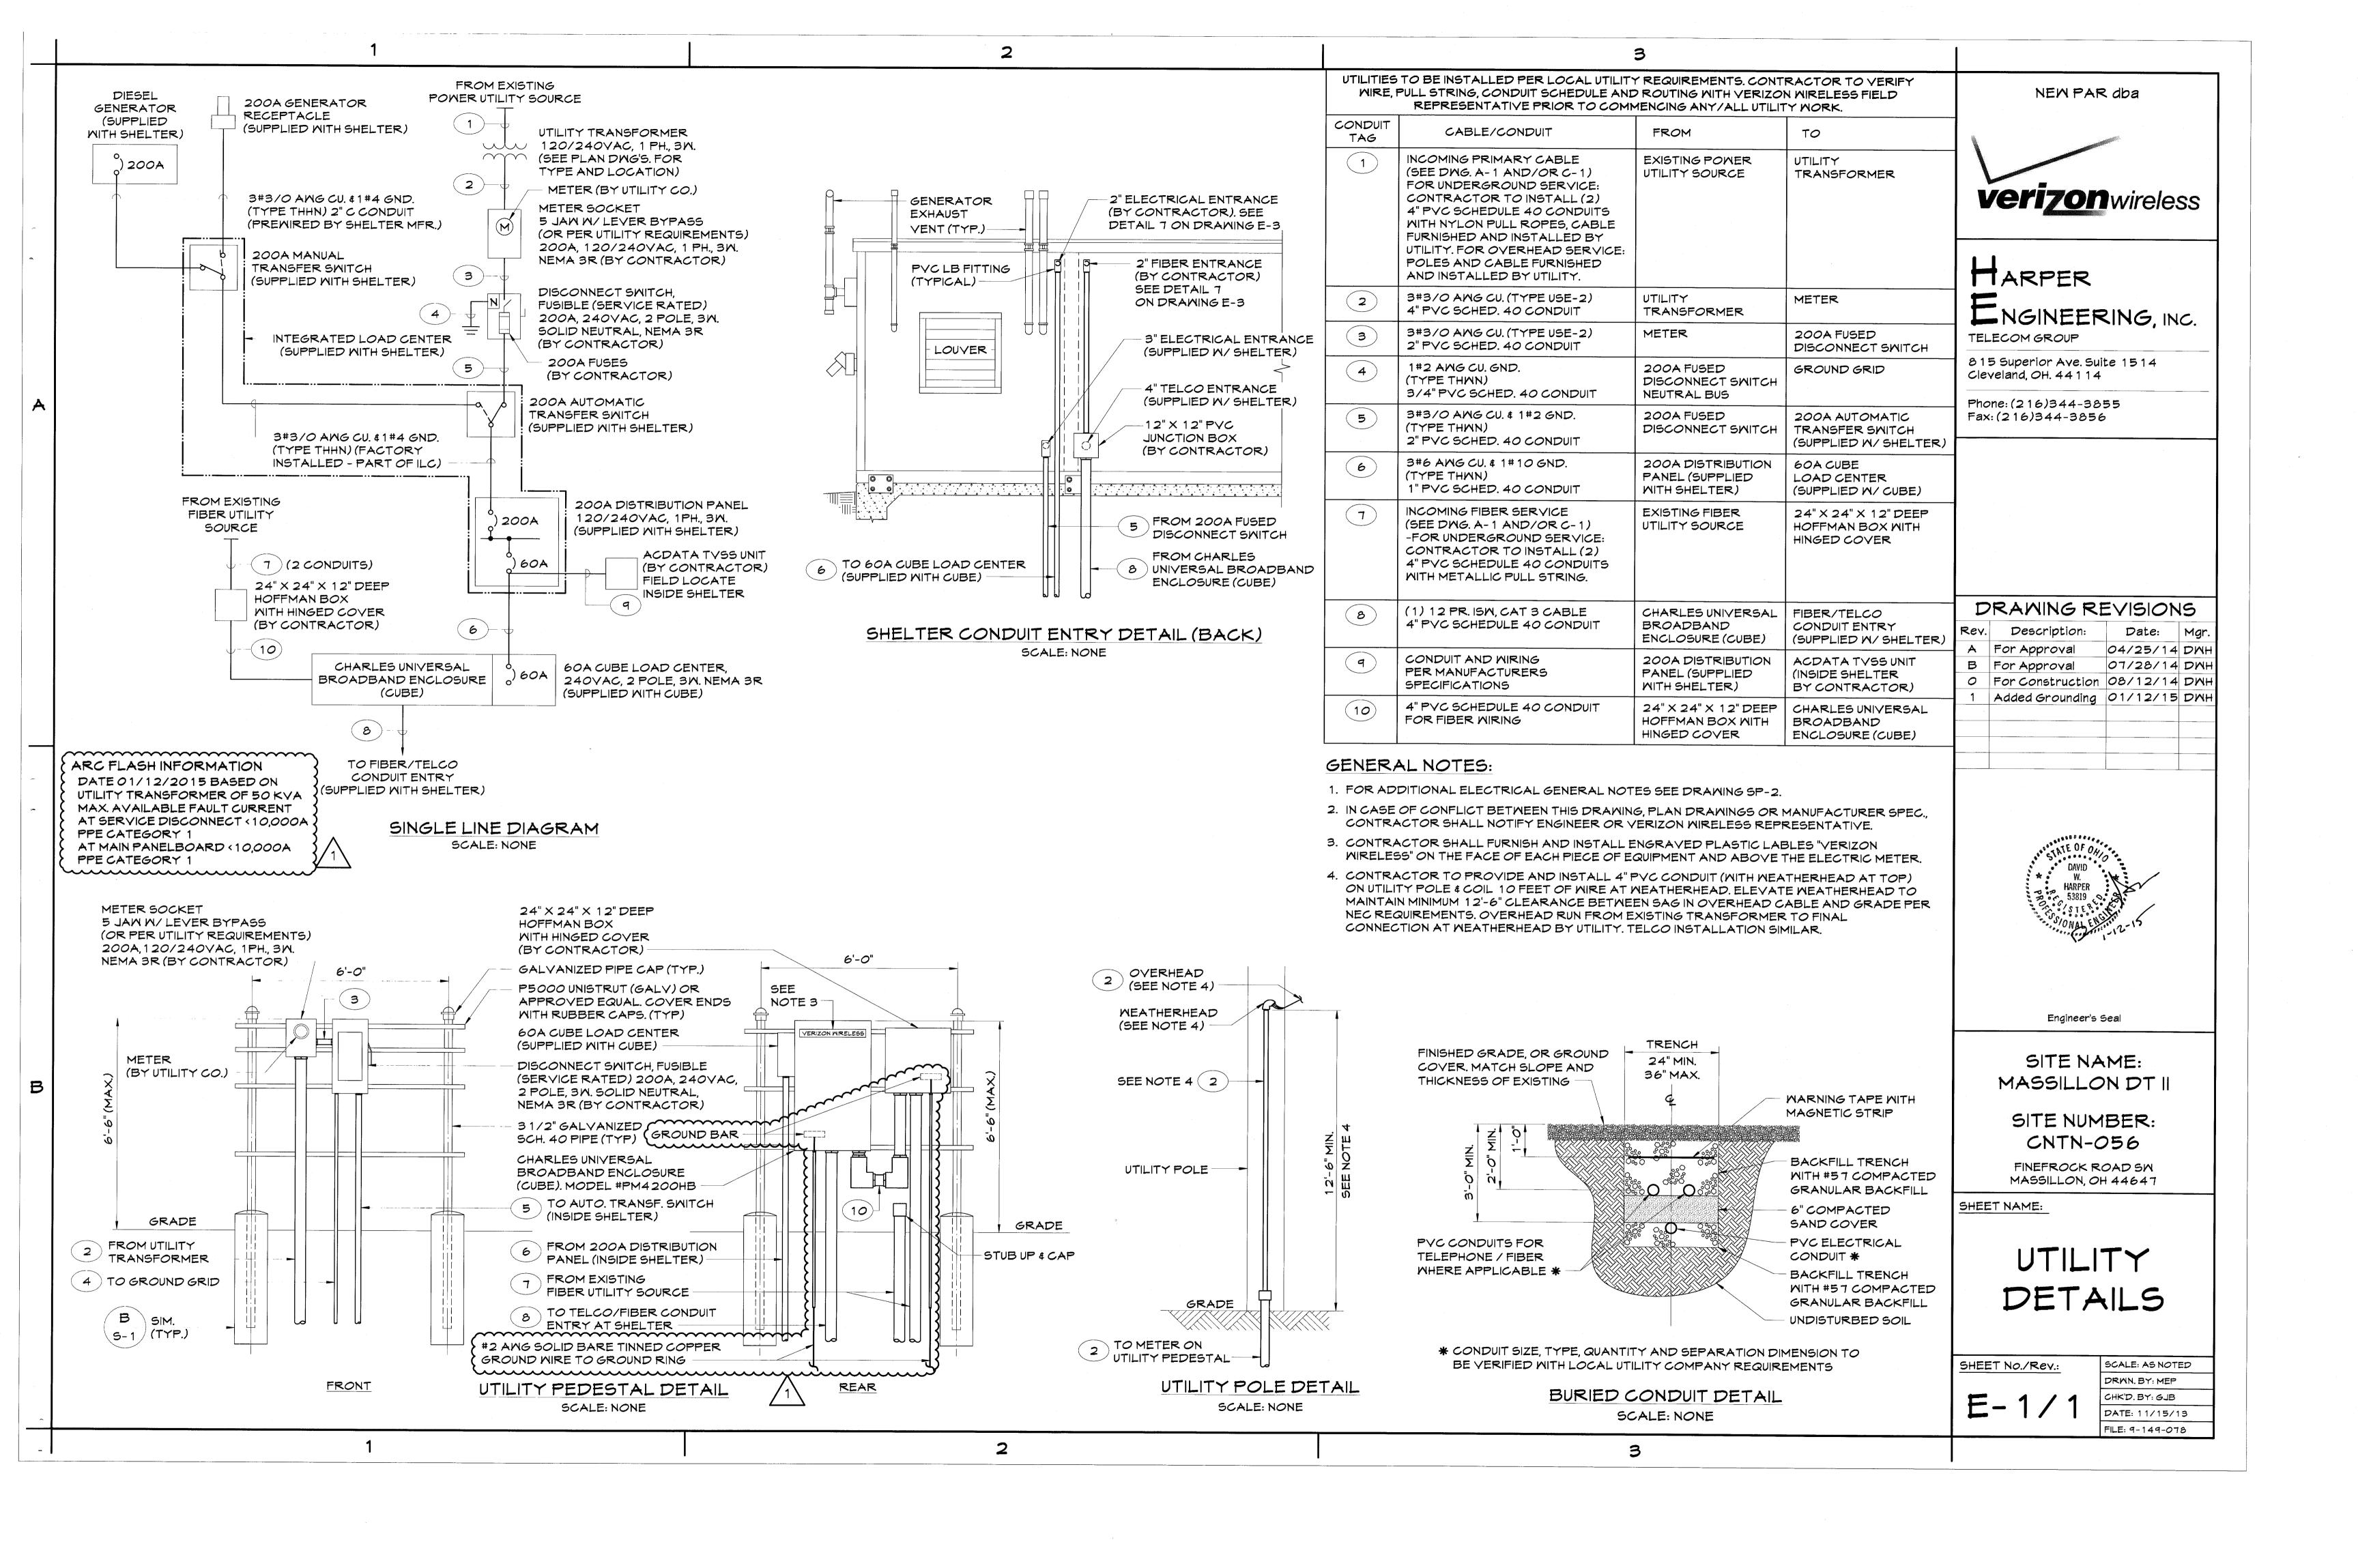

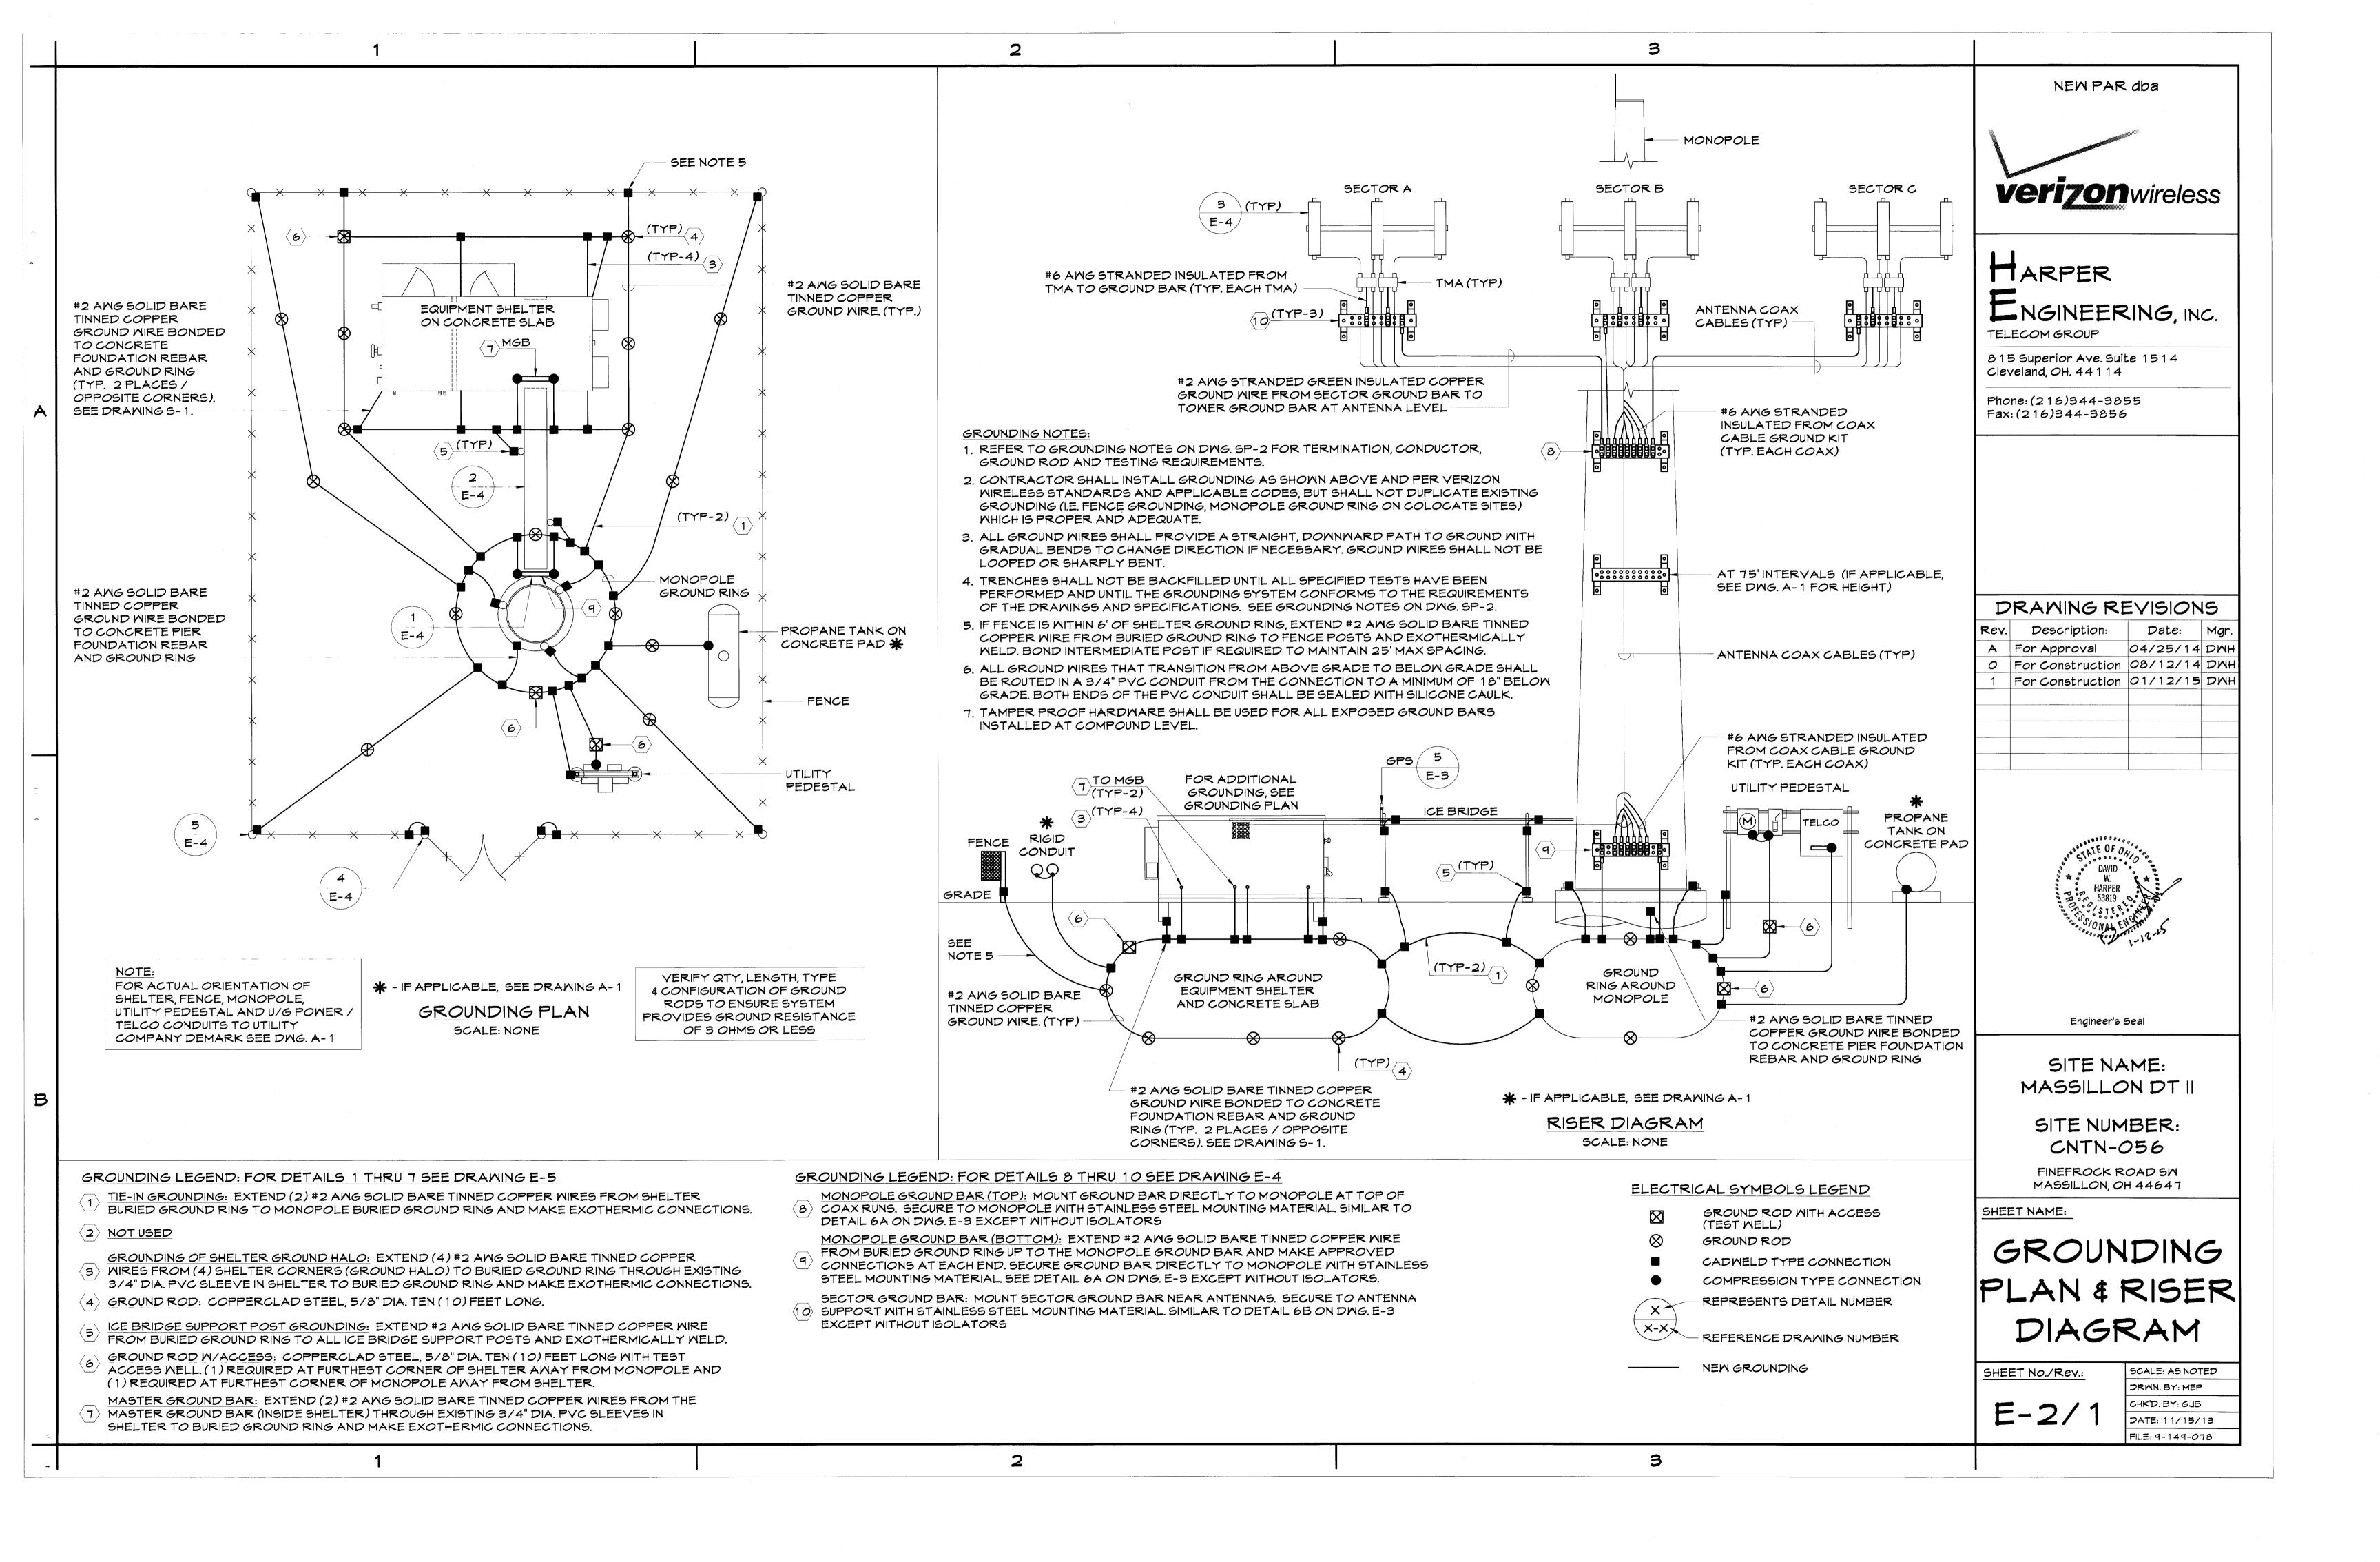



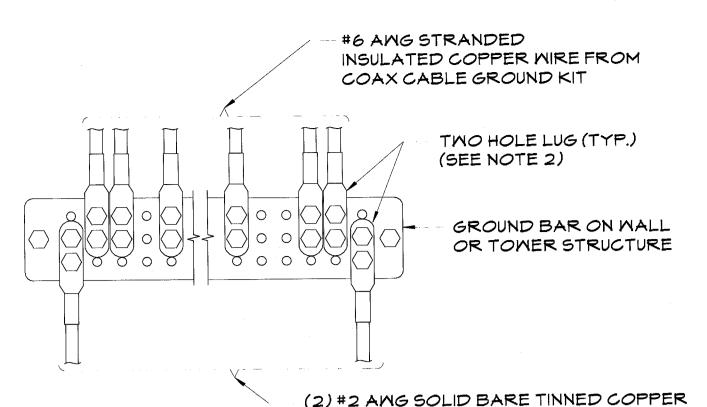



GROUND WIRES FROM GROUND BAR TO GROUND RING (SEE NOTE 1)

- 1. REFER TO RISER DIAGRAM ON DWG E-2 FOR CONNECTIONS. DOWN LEADS TO THE GROUND RING SHALL BE SLEEVED TO 18" BELOW THE SURFACE.
- 2. CONTRACTOR SHALL COAT ALL LUGS WITH AN ANTI-OXIDATION COMPOUND BEFORE ATTACHING TO GROUND BAR.

INSTALLATION OF GROUND WIRE TO GROUND BAR

DETAIL SCALE: NONE

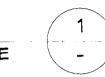

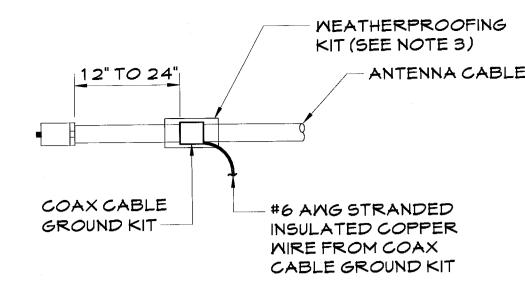


NOTES:

- 1. DO NOT INSTALL CABLE GROUND KIT AT A BEND AND ALWAYS DIRECT GROUND WIRE DOWN TO GROUND BAR. 2. GROUNDING KIT SHALL BE (TYPE AND PART NUMBER) AS
- SUPPLIED OR RECOMMENDED BY CABLE MANUFACTURER.
- 3. MEATHER PROOFING SHALL BE (TYPE AND PART NUMBER) AS SUPPLIED OR RECOMMENDED BY CABLE MANUFACTURER.

CONNECTION OF CABLE GROUND KIT TO ANTENNA CABLE

DETAIL SCALE: NONE

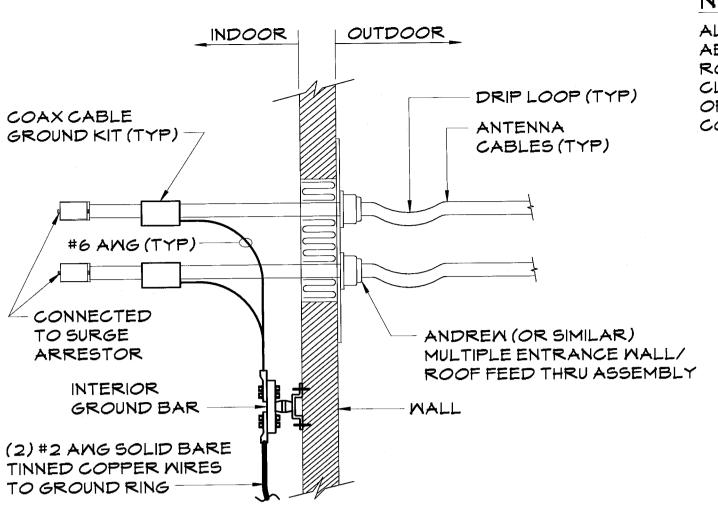

DETAIL SCALE: NONE

NOTE:

ALL GROUND WIRES THAT TRANSITION FROM ABOVE GRADE TO BELOW GRADE SHALL BE ROUTED IN A 3/4" PVC CONDUIT (NOT SHOWN FOR CLARITY) FROM THE CONNECTION TO A MINIMUM OF 18" BELOW GRADE. BOTH ENDS OF THE PVC CONDUIT SHALL BE SEALED WITH SILICONE CAULK.

> 3 1/4" MIN. CONC. WALL OR CMU. OPENING TO PROVIDE 3/4" MAX.

ANNULAR SPACE AROUND PIPE

FLAME SAFE IPC FSP 1000 PUTTY APPLIED INTO THE OPENING - 1/2" THICKNESS AT EA. MALL SURFACE

MINERAL WOOL (4 PCF) PACKED

1/2" FROM WALL SURFACES

INTO ANNULAR SPACE AND RECESSED

SEE DRAWING E-1

FOR CONDUIT SIZE

CONTRACTOR TO INSURE WATER-TIGHTNESS

CONCRETE WALL FIRE STOPPING PENETRATION

AT ALL WALL PENETRATIONS.

DETAIL

TGB

0 0 0 0 0 0 0 0 0 0 0 0 0 0

0000000000000000

SCALE: NONE



NEW PAR dba


MARPER ENGINEERING, INC. TELECOM GROUP

815 Superior Ave. Suite 1514 Cleveland, OH. 44114

Phone: (216)344-3855 Fax: (216)344-3856

DRAMING REVISIONS

Date: Mgr. Description: 04/25/14 DMH A For Approval O For Construction 08/12/14 DWH For Construction 01/12/15 DMH

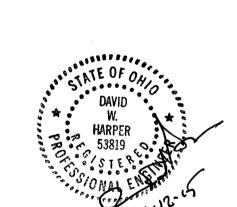

Engineer's Seal

SITE NAME: MASSILLON DT II

SITE NUMBER: CNTN-056

FINEFROCK ROAD SM MASSILLON, OH 44647

SHEET NAME:

GROUNDING DETAILS

SHEET No./Rev.:

E-3/

DRWN. BY: MEP CHK'D. BY: GJB DATE: 11/15/13 FILE: 9-149-078

SCALE: AS NOTED

TO TOMER MOUNTED TO TRANSMIT AMPLIFIER UNITS (TMA) (MHEN REQUIRED) AND RECEIVE ANTENNA JUMPER REQUIRED ONLY FOR EASE OF CONNECTION AND STRESS RX1/RX2 RX1/RX2 REDUCTION ON ANTENNA CABLES (TYPICAL) MEATHERPROOFING CONNECTOR KIT (TYPICAL) WEATHERPROOFING KIT (TYPICAL) STANDARD GROUND KIT (TYP.) (SEE NOTE) ANTENNA CABLE TO BTS (TYPICAL) FROM TMA (WHEN REQUIRED) #6 AMG STRANDED COPPER MIRE WITH GREEN, 600V, THWN INSULATION SECTOR GROUND BAR MOUNTED NEAR/BELOW ANTENNAS DO NOT INSTALL CABLE GROUND - #2 AMG STRANDED OU WIRE MITH KIT AT A BEND AND ALWAYS DIRECT GREEN, 600Y, THWN INSULATION ROUTED TO GROUND BAR AT TOP GROUND WIRE DOWN TO CIGBE OF TOWER/MONOPOLE OR ANTENNA LEVEL

> CONNECTION OF GROUND WIRE TO GROUNDING BAR (CIGBE) TOWER/MONOPOLE/ROOFTOP

> > DETAIL SCALE: NONE

GPS SHOULD HAVE CLEAR VIEW OF THE SOUTHERN HORIZON AND GROUNDED PER MANUFACTURER'S SPECIFICATIONS

> DETAIL SCALE: NONE

GPS ANTENNA INSTALLATION

GPS ANTENNA, CABLE, MOUNTING BASE, ETC. TO BE INSTALLED BY CONTRACTOR. FINAL LOCATION TO BE DETERMINED IN FIELD. ICE BRIDGE OR SUPPORT POST (SHOWN) OR WALL MOUNT BRACKET GPS ANTENNA CABLE TO EQUIPMENT CABINET

DETAIL SCALE: NONE

3

0000000000000 0 0 0 0 0 0 0 0 0 0 MATERIAL LIST

A 4 /

TINNED COPPER GROUND BAR, 1/4"X 4"X 24" TESSCO (1) CAT. NO. 482415 WITH THEFT DETERRENT HARWARE WALL MOUNTING KIT CAT. NO. 390980 OR APPROVED EQUAL


2 INSULATORS, TESSCO (PROVIDED WITH MOUNTING KIT) OR APPROVED EQUAL.


3 WALL MOUNTING BRACKET, TESSCO (PROVIDED WITH MOUNTINGKIT) OR APPROVED EQUAL.

TINNED COPPER GROUND BAR, 1/4"X 4"X 12" TESSCO (4) CAT. NO. 422409 WITH THEFT DETERRENT HARDWARE WALL MOUNTING KIT CAT. NO. 390980 OR APPROVED EQUAL.

> TOWER GROUND BAR (TGB) OR SECTOR GROUND BAR DETAIL

> > 6A (6B)

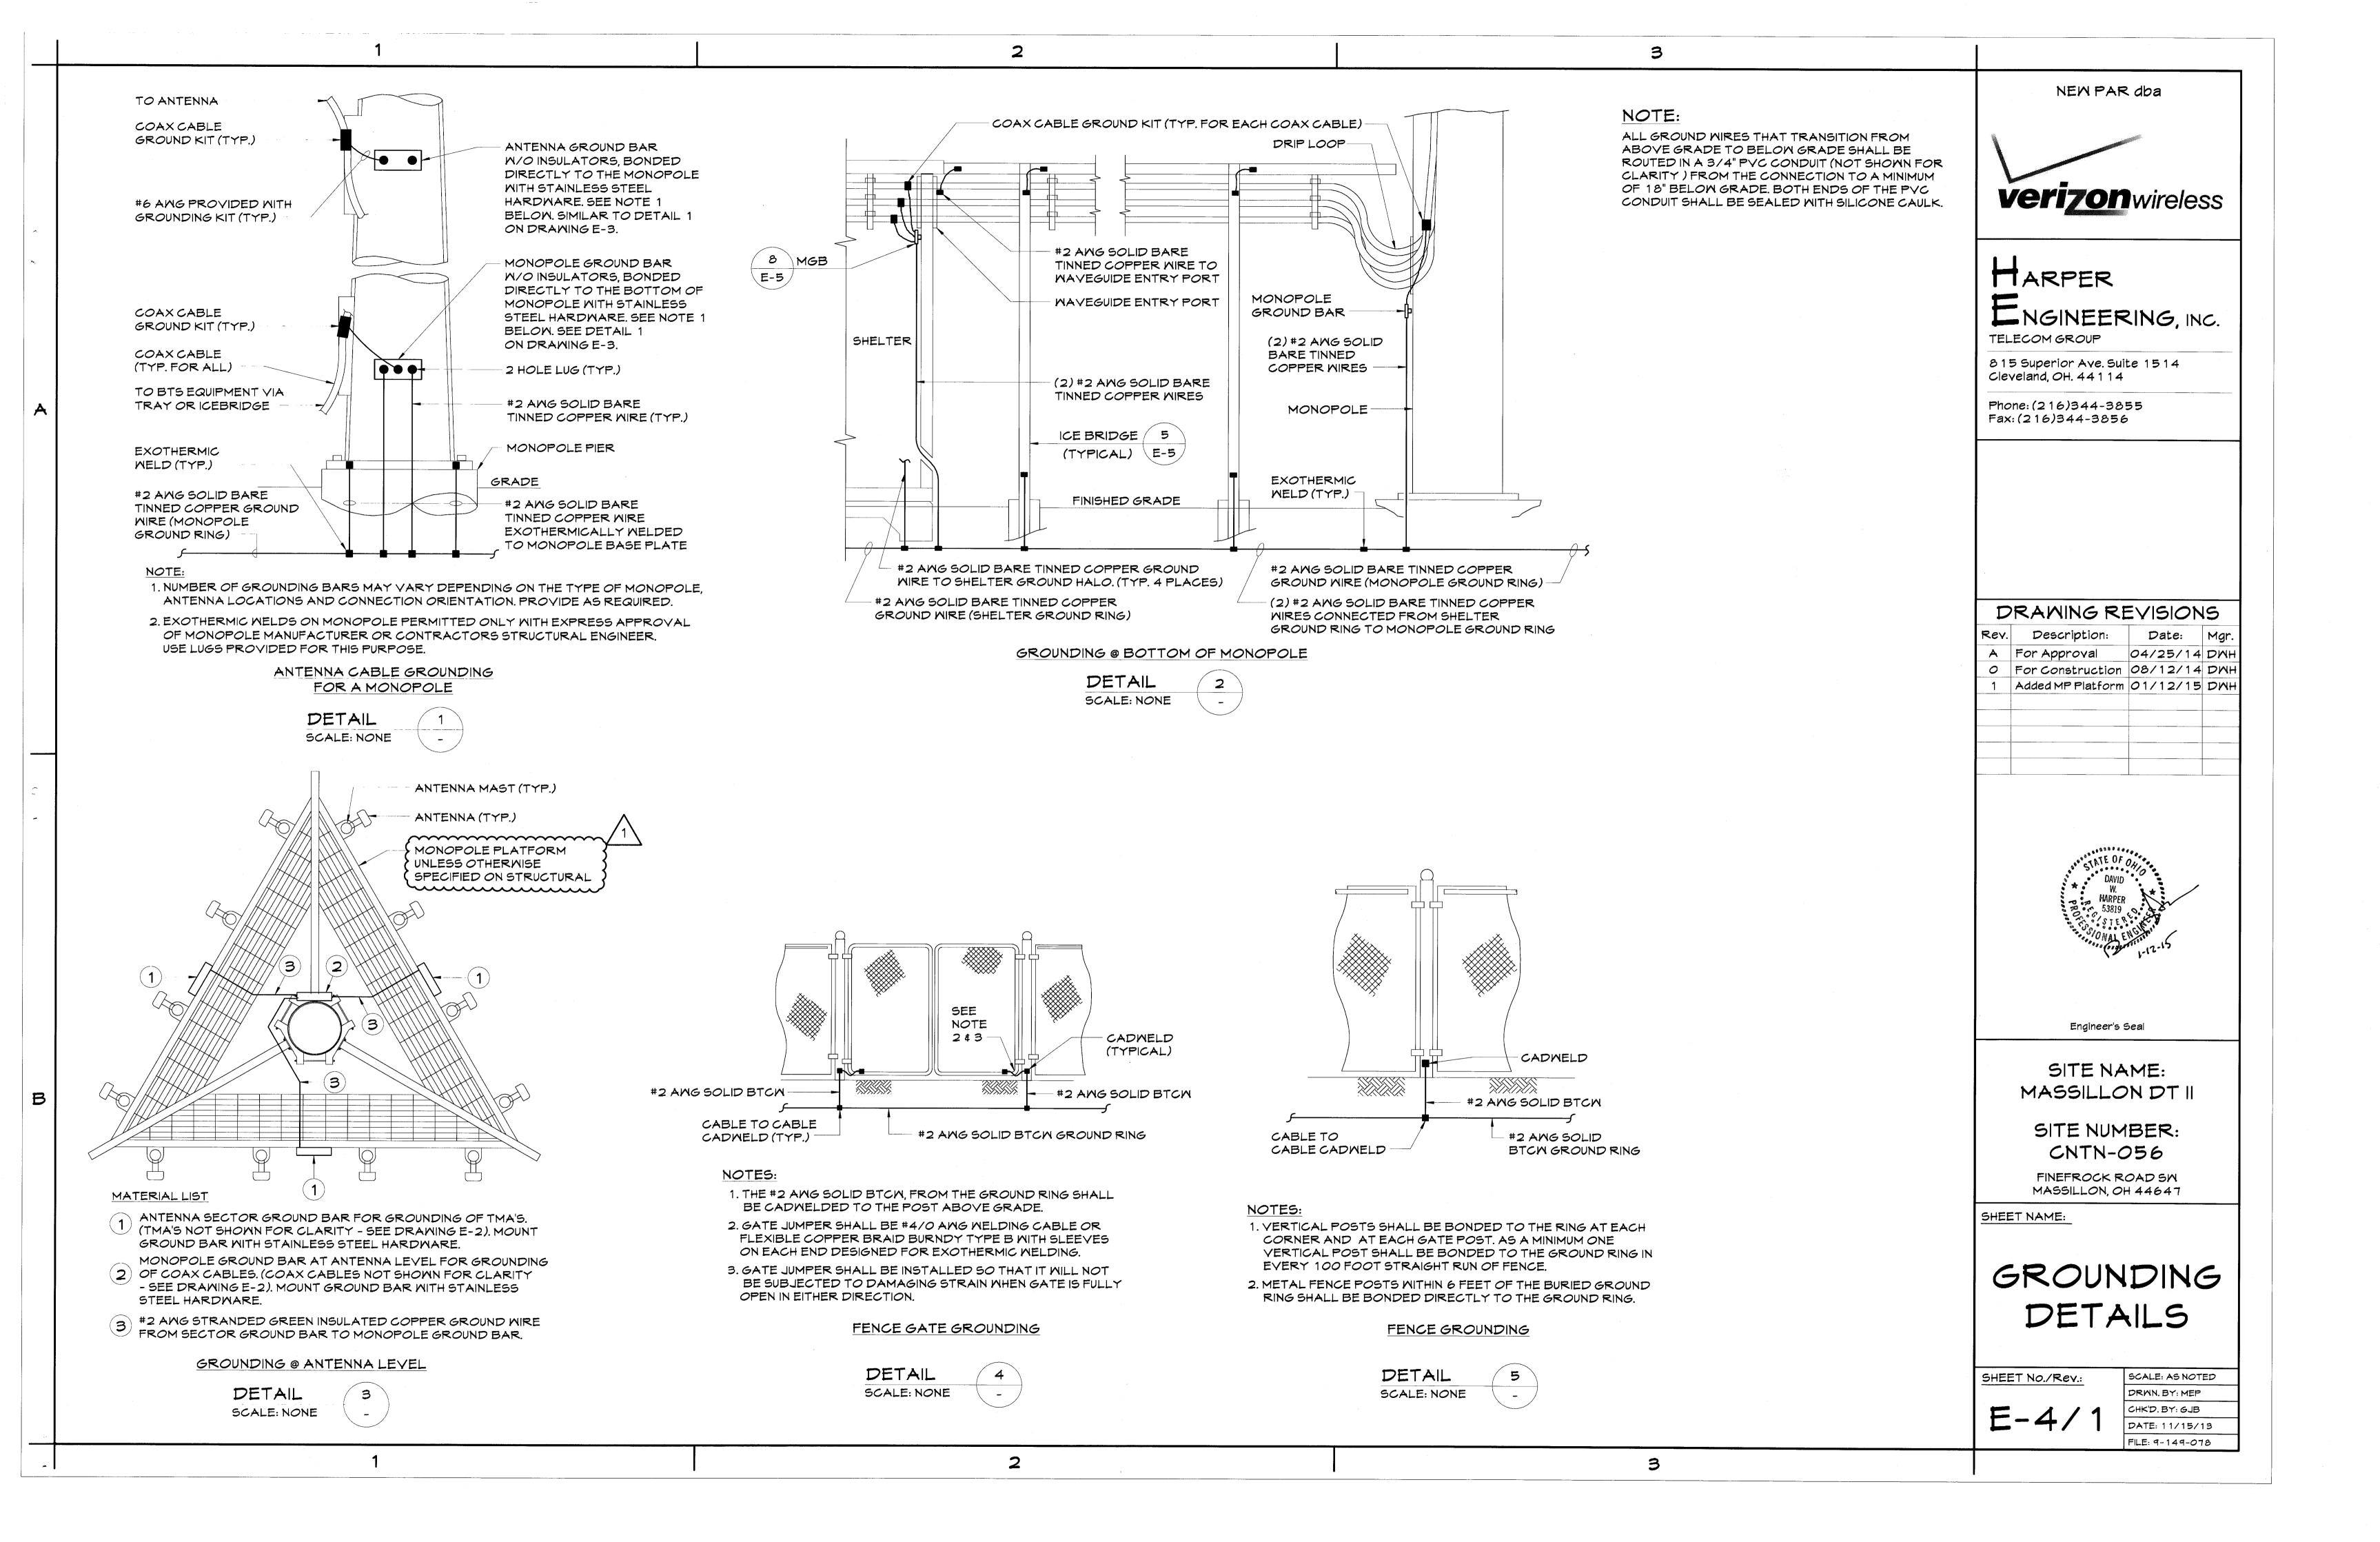

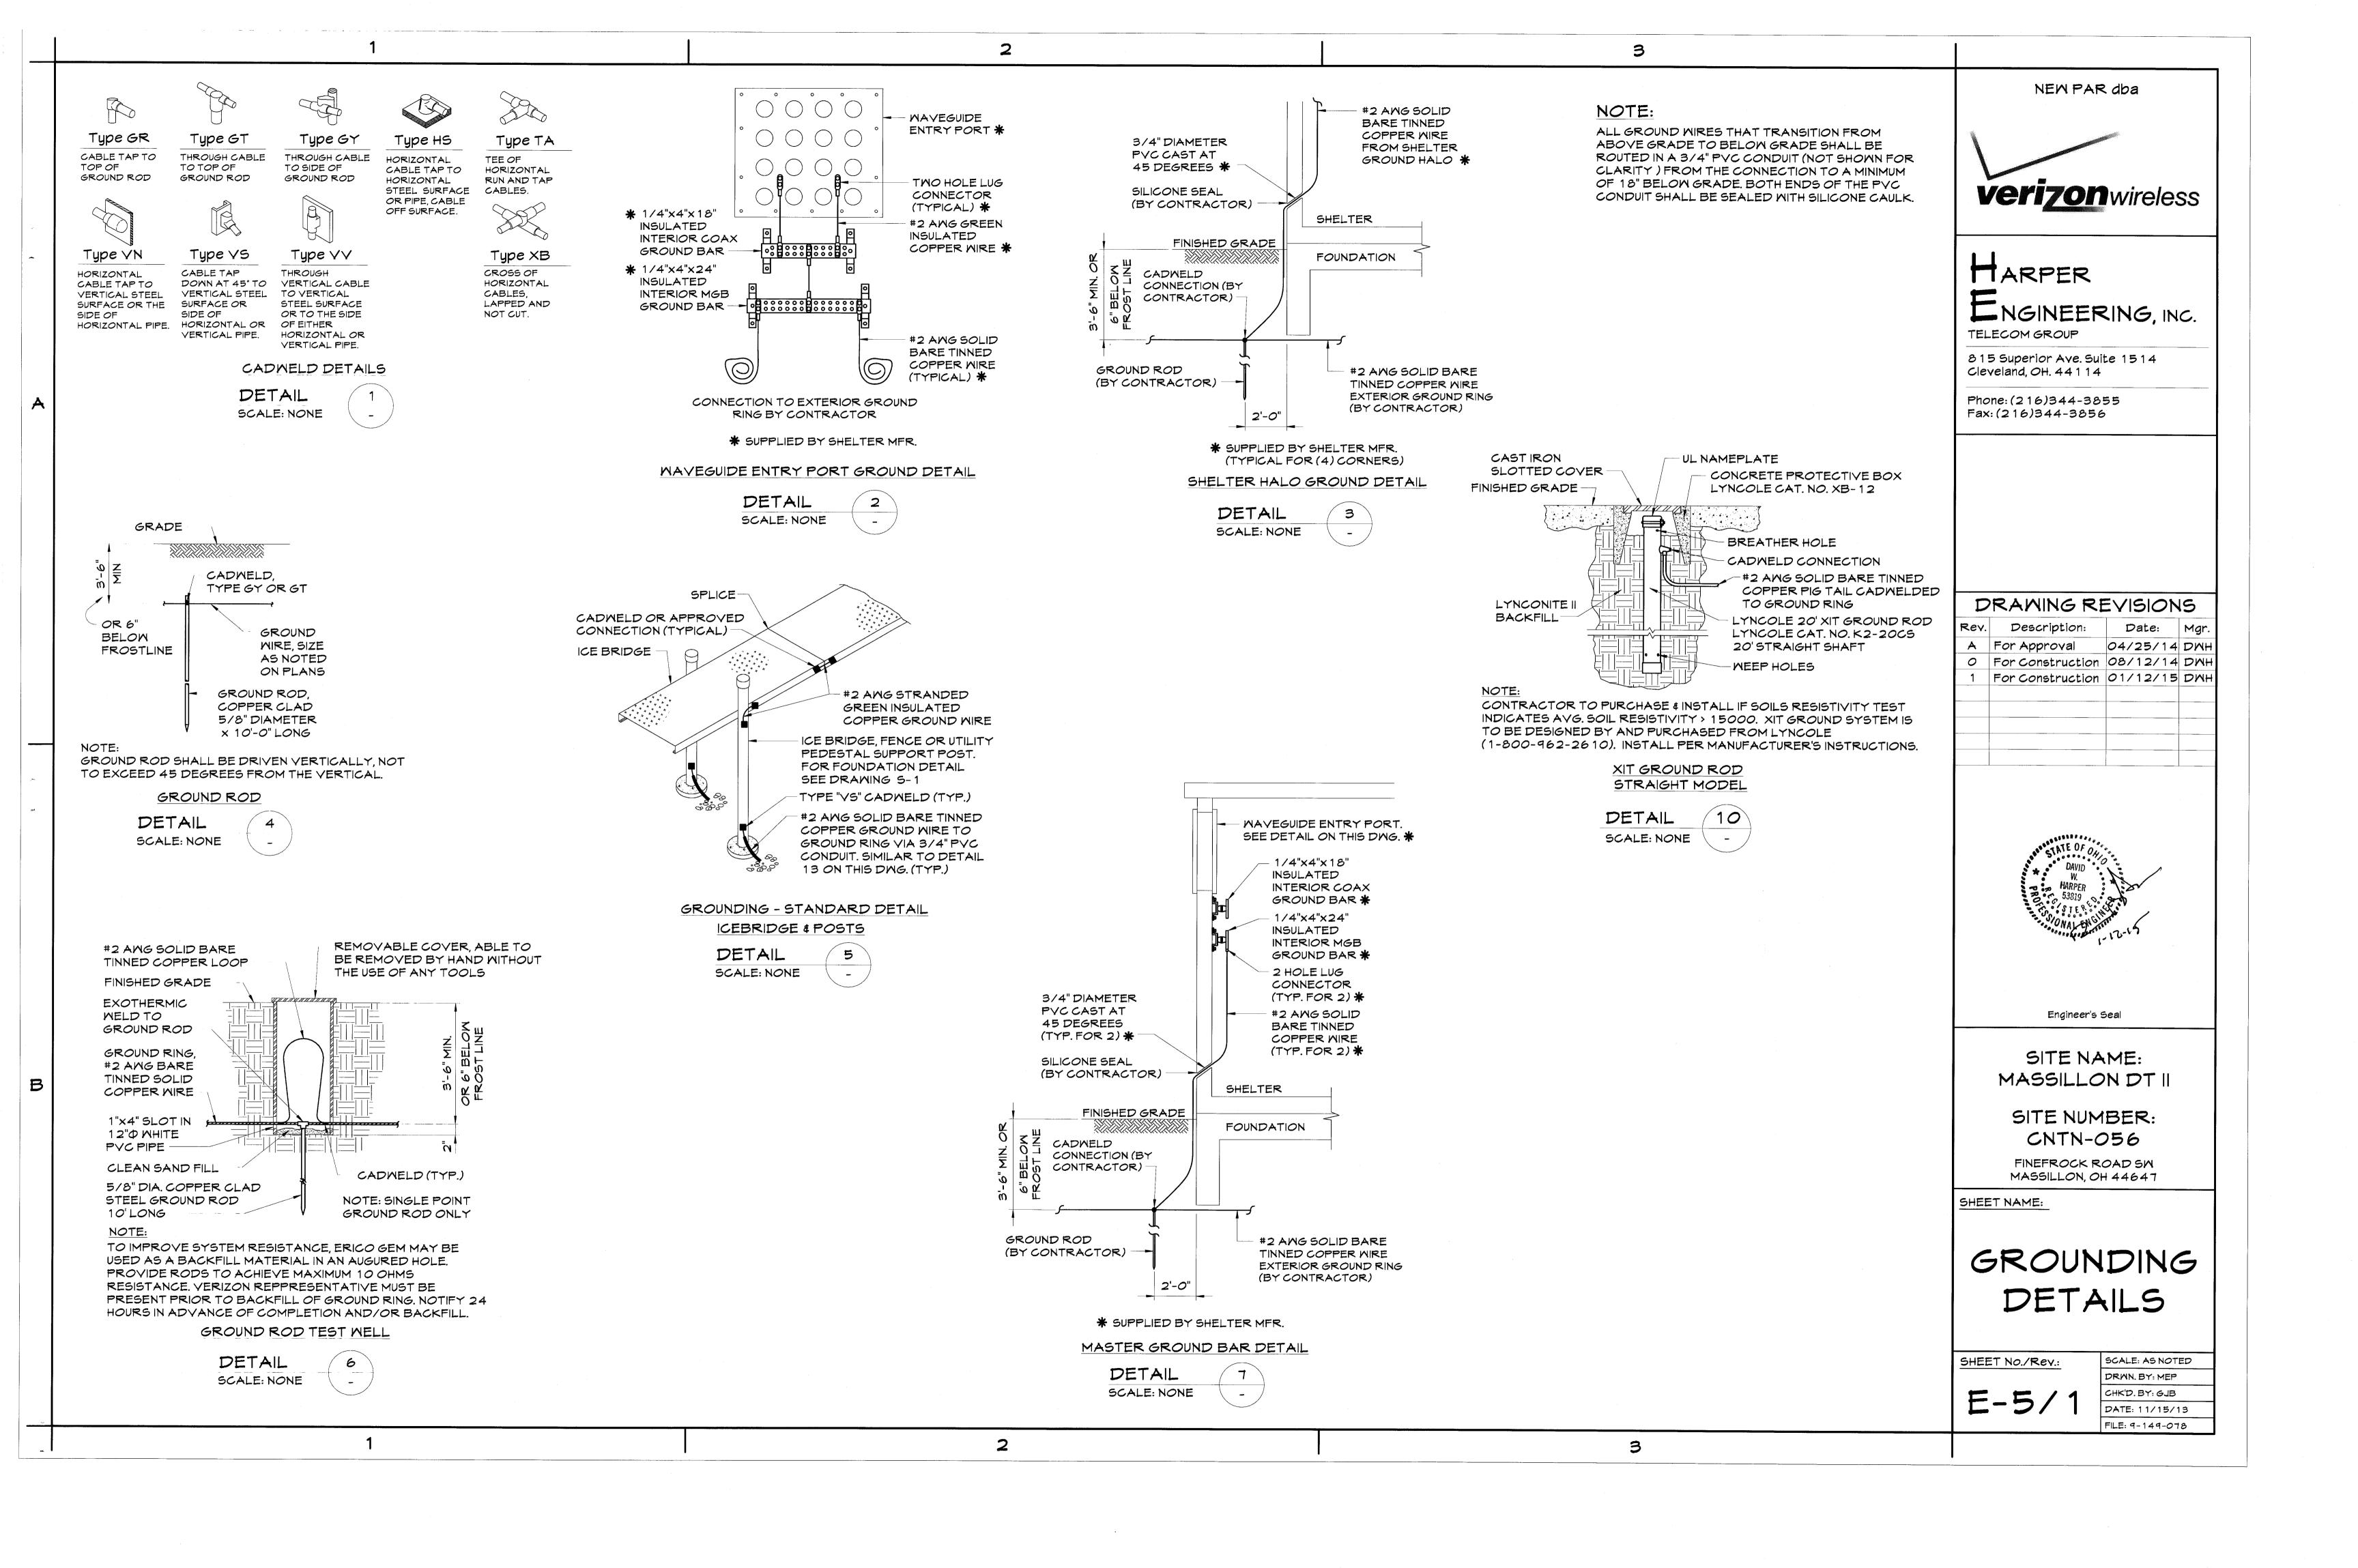

2. THE OWNER OR HIS ARCHITECT/ENGINEER RESERVES THE RIGHT TO REJECT ANY EQUIPMENT OR MATERIALS WHICH, IN HIS OPINION ARE NOT IN COMPLIANCE WITH THE CONTRACT DOCUMENTS, EITHER BEFORE OR AFTER INSTALLATION AND THE EQUIPMENT SHALL BE REPLACED WITH EQUIPMENT CONFORMING TO THE REQUIREMENTS OF THE CONTRACT DOCUMENTS BY THE CONTRACTOR AT NO COST TO THE OWNER OR HIS ARCHITECT/ENGINEER.

3. THE CONTRACTOR SHALL SUPPORT, BRACE AND SECURE EXISTING STRUCTURES AS REQUIRED. CONTRACTOR IS SOLELY RESPONSIBLE FOR THE PROTECTION OF ANY EXISTING STRUCTURES DURING CONSTRUCTION. FIELD VERIFY ALL EXISTING DIMENSIONS WHICH AFFECT THE NEW CONSTRUCTION.

4. THE CONTRACTOR SHALL NOT ALLOW OR CAUSE ANY OF THE WORK TO BE COVERED UP OR ENCLOSED UNTIL IT HAS BEEN INSPECTED BY THE GOVERNING AUTHORITIES. ANY WORK THAT IS ENCLOSED OR COVERED UP BEFORE SUCH INSPECTION AND TEST SHALL BE UNCOVERED AT THE CONTRACTOR'S EXPENSE; AFTER IT HAS BEEN INSPECTED, THE CONTRACTOR SHALL RESTORE THE WORK TO ITS ORIGINAL CONDITION AT HIS OWN EXPENSE.

5. ALL EXISTING UTILITIES, FACILITIES, CONDITIONS, AND THEIR DIMENSIONS SHOWN ON PLANS HAVE BEEN PLOTTED FROM AVAILABLE RECORDS. THE ARCHITECT/ENGINEER AND OWNER ASSUME NO RESPONSIBILITY WHATEVER AS TO THE SUFFICIENCY OR ACCURACY OF THE INFORMATION SHOWN ON THE PLANS OR THE MANNER OF THEIR REMOVAL OR ADJUSTMENT. CONTRACTOR SHALL BE RESPONSIBLE FOR DETERMINING EXACT LOCATION OF ALL SAID UTILITIES AND FACILITIES PRIOR TO START OF CONSTRUCTION. CONTRACTOR SHALL ALSO OBTAIN FROM EACH UTILITY COMPANY DETAILED INFORMATION RELATIVE TO WORKING SCHEDULES AND METHODS OF REMOVING OR ADJUSTING AFFECTED UTILITIES.

6. CONTRACTOR SHALL FIELD VERIFY ALL EXISTING UTILITIES BOTH HORIZONTALLY AND VERTICALLY PRIOR TO START OF CONSTRUCTION. ANY DISCREPANCIES OR DOUBTS AS TO THE INTERPRETATION OF PLANS SHOULD BE IMMEDIATELY REPORTED TO THE PROJECT MANAGER FOR RESOLUTION AND INSTRUCTION, AND NO FURTHER WORK SHALL BE PERFORMED UNTIL DISCREPANCY IS CHECKED AND CORRECTED BY THE ARCHITECT/ENGINEER. FAILURE TO SECURE SUCH INSTRUCTION MEANS CONTRACTOR WILL HAVE WORKED AT HIS OWN RISK AND EXPENSE. CONTRACTOR SHALL CALL O.U.P.S. AT (800) 362-2764 24 HRS PRIOR TO START OF CONSTRUCTION TO HAVE UNDERGROUND UTILITIES LOCATED AND MARKED.

7. CONTRACTORS SHALL CLEAN ENTIRE SITE AFTER CONSTRUCTION SUCH THAT NO PAPERS, TRASH, DEBRIS, WEEDS, BRUSH, OR ANY OTHER DEPOSITS REMAIN. ALL MATERIALS COLLECTED DURING CLEANING OPERATIONS SHALL BE PROPERLY DISPOSED OF OFF-SITE BY THE CONTRACTOR.

8. ALL SITE WORK SHALL BE CAREFULLY COORDINATED BY THE CONTRACTOR WITH LOCAL GAS, ELECTRIC, TELEPHONE, AND ANY OTHER UTILITY COMPANIES HAVING JURISDICTION OVER THIS LOCATION.

9. DURING CONSTRUCTION, THE CONTRACTOR SHALL AT ALL TIMES MAINTAIN THE UTILITIES OF THE BUILDING/SITE WITHOUT INTERRUPTION. SHOULD IT BE NECESSARY TO INTERRUPT ANY SERVICE OR UTILITY, THE CONTRACTOR SHALL SECURE PERMISSION IN WRITING FROM THE BUILDING/PROPERTY OWNER FOR SUCH INTERRUPTION, AT LEAST 72 HOURS IN ADVANCE. ANY INTERRUPTION SHALL BE MADE WITH A MINIMUM AMOUNT OF INCONVENIENCE TO THE BUILDING/PROPERTY OWNER AND ANY SUCH SHUTDOWN TIME SHALL BE COORDINATED WITH THE BUILDING/PROPERTY OWNER.

10. CONTRACTOR SHALL MINIMIZE DISTURBANCE TO EXISTING SITE DURING CONSTRUCTION. EROSION CONTROL MEASURES, IF REQUIRED DURING CONSTRUCTION, SHALL BE IN CONFORMANCE WITH THE OHIO STANDARDS FOR EROSION AND SEDIMENT CONTROL.

1 1. CONTRACTOR SHALL SUBMIT AT THE END OF THE PROJECT A COMPLETE SET OF AS BUILT DRAWINGS TO THE OWNER AND/OR PROJECT MANAGER.

DIVISION 2 - SITE MORK:

1. THE CONTRACTOR SHALL CALL UTILITIES PRIOR TO THE START OF CONSTRUCTION. ALL EXISTING ACTIVE SEWER, WATER, GAS, ELECTRIC, AND OTHER UTILITIES (WHERE ENCOUNTERED IN THE WORK) SHALL BE PROTECTED AT ALL TIMES, AND WHERE REQUIRED FOR THE PROPER EXECUTION OF THE WORK, SHALL BE RELOCATED AS DIRECTED BY THE PROJECT MANAGER. EXTREME CAUTION SHOULD BE USED BY THE CONTRACTOR WHEN EXCAVATING OR PIER DRILLING AROUND OR NEAR UTILITIES. CONTRACTOR SHALL PROVIDE SAFETY TRAINING FOR THE WORKING CREW. THIS WILL INCLUDE BUT NOT LIMITED TO:

A. FALL PROTECTION
B. CONFINED SPACE

C. ELECTRICAL SAFETY

D. TRENCHING AND EXCAVATION

2. REMOVE FROM SITE/OWNER'S PROPERTY ALL WASTE MATERIALS, UNUSED EXCAVATED MATERIAL INCLUDING MATERIAL CLASSIFIED UNSATISFACTORY, CONTAMINATED OR DANGEROUS TRASH AND DEBRIS, AND DISPOSE OF IN A LEGAL MANNER.

3. ALL EXISTING INACTIVE SEWER, WATER, GAS, ELECTRIC AND OTHER UTILITIES, WHICH INTERFERE WITH THE EXECUTION OF THE WORK, SHALL BE REMOVED AND/OR CAPPED, PLUGGED OR OTHERWISE DISCONTINUED AT POINTS WHICH WILL NOT INTERFERE WITH THE EXECUTION OF THE WORK, SUBJECT TO THE APPROVAL OF ENGINEERING AND DOCUMENTED ON THE AS-BUILT DRAWINGS.

4. THE AREAS OF THE OWNERS PROPERTY DISTURBED BY THE WORK AND NOT COVERED BY THE BUILDING OR DRIVEWAY, SHALL BE GRADED TO A UNIFORM SLOPE, FERTILIZED, SEEDED, AND COVERED WITH MULCH AS SPECIFIED IN THE SPECIFICATION LANDSCAPE WORK.

5. CONTRACTOR SHALL MINIMIZE DISTURBANCE TO EXISTING SITE DURING CONSTRUCTION. EROSION CONTROL MEASURES, IF REQUIRED DURING CONSTRUCTION, SHALL BE IN CONFORMANCE WITH THE LOCAL AND OBC 2011/IBC 2009 STANDARD GUIDELINES FOR EROSION AND SEDIMENT CONTROL.

6. CONTRACTOR IS RESPONSIBLE FOR LAYOUT AND CONSTRUCTION STAKING.
CONTRACTOR SHALL ESTABLISH GRADE AND LINE STAKES PRIOR TO CONSTRUCTION.

7. IF DEVIATION FROM THE SUBSURFACE CONDITIONS NOTED IN THE GEOTECH REPORT ARE ENCOUNTERED, DURING CONSTRUCTION, THE OWNER'S REPRESENTATIVE IS TO BE CONTACTED IMMEDIATELY TO DETERMINE IF CHANGES IN THE FOUNDATION DESIGN ARE REQUIRED.

DIVISION 3 - CONCRETE:

1. MINIMUM ALLOWABLE CONCRETE COMPRESSIVE STRENGTH SHALL BE 4000 PSI AT 28 DAYS WHEN TESTED IN ACCORDANCE WITH THE AMERICAN SOCIETY FOR TESTING AND MATERIALS METHODS STANDARDS ASTM C 1 72, ASTM C 3 1 AND ASTM C 3 9 UNLESS OTHERWISE NOTED.

2. CONCRETE FOR ALL FOUNDATIONS: TYPE I PORTLAND CEMENT, 540 LBS PER CUBIC YARD OF CONCRETE MINIMUM CEMENT CONTENT WITH 1-INCH MAXIMUM SIZE AGGREGATE, SLUMP RANGE 3 INCHES TO 5 INCHES, TOTAL AIR CONTENT 4 PERCENT TO 7 PERCENT BY VOLUME. AIR ENTRAINING ADMIXTURE REQUIRED TO CONTROL TOTAL AIR CONTENT, WATER REDUCING ADMIXTURE PERMITTED TO OBTAIN SLUMP OVER 3-INCHES.

3. ALL CONCRETE CONSTRUCTION SHALL MEET THE REQUIREMENTS OF THE AMERICAN CONCRETE INSTITUTE (ACI 3 18) BUILDING CODE REQUIREMENTS FOR REINFORCED CONCRETE AND (ACI 30 1) STANDARD SPECIFICATION FOR STRUCTURAL CONCRETE.

4. REBARS SHALL BE ASTM A-615 DEFORMED TYPE WITH MINIMUM YIELD STRENGTH OF 60,000 PSI (40,000 PSI GRADE MAY BE USED FOR TIES & STIRRUPS). WELDED WIRE FABRIC SHALL CONFORM TO ASTM A-185.

5. DETAILING SHALL BE IN ACCORDANCE WITH MANUAL OF STANDARD PRACTICE OF DETAILING REINFORCED CONCRETE STRUCTURES (ACI STD-3 15-99).

6. CHAMFER ALL EXPOSED EDGES OF CONCRETE 3/4".

7. REINFORCING STEEL SHALL BE ACCURATELY PLACED AND ADEQUATELY SECURED IN POSITION. LOCATION OF REINFORCEMENT SHALL BE INDICATED ON THE DRAWINGS. THE FOLLOWING MINIMUM COVER (INCHES) FOR REINFORCEMENT SHALL BE PROVIDED, EXCEPT AS NOTED ON DRAWINGS.

MINIMUM COVER (INCHES)

CAST AGAINST AND PERMANENTLY EXPOSED TO EARTH ... 3"

EXPOSED TO EARTH OR WEATHER:

#6 THROUGH #18 ... 2"

#5 BAR AND SMALLER ... 1-1/2"

8. TESTS
CONCRETE MATERIALS AND OPERATIONS SHALL BE TESTED AND INSPECTED BY THE
CONSTRUCTION MANAGER AS THE WORK PROGRESSES. FAILURE TO DETECT ANY
DEFECTIVE WORK OR MATERIAL SHALL NOT IN ANY WAY PREVENT LATER REJECTION
WHEN SUCH DEFECT IS DISCOVERED NOR SHALL IT OBLIGATE THE ENGINEER FOR FINAL
ACCEPTANCE.

A. FIVE CONCRETE TEST CYLINDERS SHALL BE TAKEN OF THE TOWER AND/OR SHELTER FOUNDATION. TWO SHALL BE TESTED @ THREE DAYS, TWO @ TWENTY-EIGHT DAYS. THE FIFTH CYLINDER SHALL BE KEPT SEPARATELY, IF REQUIRED TO BE USED IN THE FUTURE.

B. ONE ADDITIONAL TEST CYLINDER SHALL BE TAKEN DURING COLD WEATHER AND CURED ON SITE UNDER SAME CONDITIONS AS CONCRETE IT REPRESENTS.

C. ONE SLUMP TEST SHALL BE TAKEN FOR EACH SET OF TEST CYLINDERS TAKEN.

9. PLACING CONCRETE

A. THE CONSTRUCTION MANAGER SHALL BE NOTIFIED NOT LESS THAN 24 HOURS IN ADVANCE OF CONCRETE PLACEMENT, UNLESS INSPECTION IS WAIVED IN EACH CASE, PLACING OF CONCRETE SHALL BE PERFORMED ONLY IN THE PRESENCE OF THE ENGINEER. CONCRETE SHALL NOT BE PLACED UNTIL ALL FORMWORK, EMBEDDED PARTS, STEEL REINFORCEMENT, FOUNDATION SURFACES AND JOINTS INVOLVED IN THE PLACING HAVE BEEN APPROVED, AND UNTIL FACILITIES ACCEPTABLE TO THE OWNER'S REPRESENTATIVE HAVE BEEN PROVIDED AND MADE READY FOR ACCOMPLISHMENT OF THE WORK AS SPECIFIED. CONCRETE MAY NOT BE ORDERED FOR PLACEMENT UNTIL ALL ITEMS HAVE BEEN APPROVED AND THE OWNER'S REPRESENTATIVE HAS PERFORMED A FINAL INSPECTION AND GIVEN APPROVAL TO START PLACEMENT IN WRITING.

B. PLACEMENT OF CONCRETE SHALL BE IN ACCORDANCE WITH ACI 30 1.

10. PROTECTION

A. IMMEDIATELY AFTER PLACEMENT, THE CONTRACTOR SHALL PROTECT THE CONCRETE FROM PREMATURE DRYING, EXCESSIVELY HOT OR COL TEMPERATURES, AND DAMAGE TO EXPOSED SURFACES (PER ACI 305/306). FINISHED WORK SHALL BE PROTECTED.

B. CONCRETE SHALL BE MAINTAINED WITH MINIMAL MOISTURE LOSS AT RELATIVELY CONSTANT TEMPERATURE FOR A PERIOD NECESSARY FOR HYDRATION OF CEMENT AND HARDENING OF CONCRETE.

1 1. ALL CONCRETE SHALL BE CONSOLIDATED BY INTERNAL VIBRATION IN ACCORDANCE WITH ACI 309-72 RECOMMENDED PRACTICE FOR CONSOLIDATION OF CONCRETE.

DIVISION 5 - STRUCTURAL STEEL:

1. DETAIL, FABRICATE AND ERECT STRUCTURAL STEEL IN ACCORDANCE WITH THE 9TH EDITION AISC "MANUAL OF STEEL CONSTRUCTION" (ASD), AMS D 1.1 AND OBC 2011/IBC 2009. STRUCTURAL STEEL SHALL COMPLY WITH THE FOLLOWING: A. ASTM A992, GRADE 50, M SECTIONS.

B. ASTM A36, GRADE 36, CHANNELS, ANGELS, PLATES, RODS,

U-BOLTS AND ANCHOR BOLTS.

C. ALL STRUCTURAL STEEL SHALL BE HOT DIPPED GALVANIZED PER ASTM A 123.

D. STRUCTURAL BOLTED CONNECTIONS SHALL BE MADE WITH ASTM A325 BOLTS IN BEARING TYPE CONNECTIONS.

2. THE CONTRACTOR SHALL PROVIDE ADEQUATE SHORING AND/OR BRACING WHERE REQUIRED DURING CONSTRUCTION UNTIL ALL CONNECTIONS ARE COMPLETE.

3. ANY FIELD CHANGES OR SUBSTITUTIONS SHALL HAVE PRIOR APPROVAL FROM THE CONSTRUCTION MANAGER.

4. TIGHTEN HIGH STRENGTH BOLTS TO A SNUG TIGHT CONDITION WHERE ALL PLIES IN A JOINT ARE IN FIRM CONTACT BY EITHER

A. A FEW IMPACTS OF A IMPACT WRENCH

INSPECTION IS ACCEPTABLE.

B. THE FULL EFFORT OF A PERSON USING A SPUD WRENCH.

5. MELDIN

A. ALL WELDING SHALL BE DONE BY CERTIFIED WELDERS. CERTIFICATION DOCUMENTS SHALL BE MADE AVAILABLE FOR ENGINEER'S AND/OR OWNER'S REVIEW IF REQUESTED.

B. WELDING ELECTRODES FOR MANUAL SHIELDED METAL ARC WELDING SHALL CONFORM TO ASTM A-233, E70 SERIES. BARE ELECTRODES AND GRANULAR FLUX USED IN THE SUBMERGED ARC PROCESS SHALL CONFORM TO AISC SPECIFICATIONS.

C. FIELD WELDING SHALL BE DONE AS PER AWS D 1.1 REQUIREMENTS. VISUAL

6. PROTECTION

A. UPON COMPLETION OF ERECTION, INSPECT ALL GALVANIZED STEEL AND PAINT ANY FIELD CUTS, WELDS, OR GALVANIZED BREAKS WITH ZINC BASED PAINT. COLOR TO MATCH THE GALVANIZING PROCESS.

NEW PAR dba



HARPER

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TELECOM GROUP

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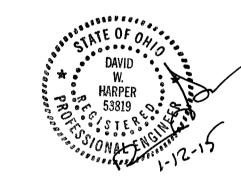
DRAMING REVISIONS

Rev. Description: Date: Mgr.

A For Approval 04/25/14 DWH

O For Construction 08/12/14 DWH

1 For Construction 01/12/15 DWH



Engineer's Seal

SITE NAME: MASSILLON DT II

SITE NUMBER: CNTN-056

FINEFROCK ROAD 5M MASSILLON, OH 44647

SHEET NAME:

GENERAL

SHEET No./Rev.:

SCALE: AS NOTED

DRWN, BY: MEP

SP-1/1

CHK'D. BY: GJB

DATE: 11/15/13

FILE: 9-149-078

QUALITY ASSURANCE:

- 1. ALL CONTRACTOR FURNISHED MATERIALS AND EQUIPMENT SPECIFIED ON THE DRAWINGS SHALL BE NEW AND UNUSED, OF CURRENT MANUFACTURE AND OF THE HIGHEST GRADE.
- 2. ALL EQUIPMENT, MATERIALS AND INSTALLATION METHODS SPECIFIED ON THE PROJECT DRAWINGS SHALL BE DESIGNED AND FABRICATED IN COMPLIANCE WITH APPLICABLE FEDERAL, STATE, AND LOCAL CODES AND REGULATIONS, AND APPROPRIATE INDUSTRIAL CONSENSUS STANDARDS AND CODES INCLUDING ANSI, IEEE, NEMA, NFPA AND UL, ALL AS REVISED AS OF THE DATE OF THIS WORK PACKAGE.
- 3. ALL ELECTRICAL ITEMS BOTH CONTRACTOR AND OWNER FURNISHED SHALL BE CHECKED FOR AGREEMENT WITH THE PROJECT DRAWINGS AND SPECIFICATIONS AND SHALL BE VISUALLY INSPECTED TO ENSURE THAT EQUIPMENT IS UNDAMAGED AND IS IN PROPER ALIGNMENT, INSTALLED PER MANUFACTURER'S INSTRUCTIONS, ELECTRICAL CONNECTIONS ARE TIGHT AND PROPERLY INSULATED WHERE REQUIRED. FUSES ARE OF THE PROPER TYPE AND SIZE, AND ELECTRICAL ENCLOSURES ARE OF THE PROPER NEMA TYPE.
- 4. NOTIFY OWNER IN WRITING OF ALL DISCREPANCIES BETWEEN DRAWINGS/SPECIFICATIONS AND FIELD INSTALLATIONS, OR IF THE VISUAL INSPECTIONS SHOW DAMAGE OR IMPROPER INSTALLATION.

<u>GENERAL:</u>

- 1. THE EQUIPMENT AND MATERIAL SHALL BE FURNISHED AND INSTALLED T*O O*PERATE SAFELY AND CONTINUOUSLY OUTDOORS WITH NO PROTECTION FROM THE WEATHER.
- 2. ELECTRICAL MORK REPRESENTED ON THE PROJECT DRAWINGS IS SHOWN DIAGRAMMATICALLY. EXACT LOCATIONS AND ELEVATIONS OF ELECTRICAL EQUIPMENT SHALL BE DETERMINED IN THE FIELD AND VERIFIED WITH THE OWNER'S REPRESENTATIVE.
- 3. CONTRACTOR SHALL COORDINATE THE INSTALLATION OF TEMPORARY, IF REQUIRED, AND PERMANENT POWER WITH THE LOCAL UTILITY COMPANY. THE TEMPORARY POWER AND ALL HOOKUP COSTS ARE TO BE PAID BY THE CONTRACTOR.
- 4. PROVIDE MOLDED CASE, BOLT-ON, THERMAL MAGNETIC TRIP, SINGLE, TWO OR THREE POLE CIRCUIT BREAKERS. MULTIPLE POLE CIRCUIT BREAKERS SHALL BE SINGLE HANDLE COMMON TRIP. SHORT CIRCUIT INTERRUPTING RATING SHALL BE AS REQUIRED FOR AVAILABLE FAULT CURRENTS. ALL CIRCUIT BREAKERS, FUSES AND ELECTRICAL EQUIPMENT SHALL HAVE A SHORT CIRCUIT INTERRUPTING RATING EQUAL TO OR GREATER THAN THAT SHOWN ON PROJECT DRAWINGS.
- 5. CONTRACTOR SHALL PERFORM ALL EXCAVATION, TRENCHING, BACKFILLING, AND REMOVAL OF DEBRIS IN CONNECTION WITH THE ELECTRICAL WORK IN ACCORDANCE WITH THE PROJECT DRAWINGS. CONTRACTOR SHALL COORDINATE THE INSTALLATION OF UNDERGROUND UTILITIES AND GROUNDING WITH THE FOUNDATION INSTALLATION.
- 6. CONTRACTOR SHALL PROVIDE ALL NECESSARY SUPPORTS FOR EQUIPMENT INSTALLED AS PART OF THIS PROJECT. SUPPORTS SHALL CONSIST OF GALVANIZED STEEL FRAMES, PLATES, BRACKETS, RACKS AND OTHER SHAPES OF ADEQUATE SIZE AND FASTENED WITH BOLTS, SCREWS OR BY WELDING TO PROVIDE RIGID SUPPORT.
- 1. CONTRACTOR SHALL CALL THE APPROPRIATE UTILITIES PROTECTION SERVICE BEFORE ANY UNDERGROUND WORK IS PERFORMED, SUCH AS TRENCHING, EXCAYATING, AND DRIVING GROUND RODS.
- 8. CONTRACTOR SHALL SEAL AROUND ELECTRICAL PENETRATIONS THROUGH FIRE-RATED WALLS/FLOORS USING APPROVED FIRE STOP MATERIALS TO MAINTAIN THE FIRE RESISTANCE RATING.
- 9. ALL ELECTRICAL EQUIPMENT SHALL BE LABLED WITH PERMANENTLY ENGRAVED LAMINATED PHENOLIC NAMEPLATES WITH WHITE ON BLUE BACKGROUND (MINIMUM LETTER HEIGHT SHALL BE 1/2 - INCH). NAMEPLATES SHALL BE FASTENED WITH STAINLESS STEEL SCREWS.

RACEMAYS:

- . CONDUIT AND CONDUIT FITTINGS SHALL MEET ANSI AND NEC STANDARDS FOR MATERIAL AND MORKMANSHIP AND SHALL BE ULLISTED.
- A. RIGID STEEL CONDUIT (FOR ALL ABOVE GRADE WORK) SHALL CONFORM TO ANSI C80.1 AND THE REQUIREMENTS OF NEC. PARAGRAPH 344 AND BE STANDARD MEIGHT, MILD RIGID STEEL, HOT DIP GALVANIZED WITH INSIDE AND OUTSIDE FINISHED WITH A PROTECTIVE ZINC COATING. COUPLING, ELBOWS AND BENDS SHALL MEET THESE SAME REQUIREMENTS. FITTINGS SHALL BE OF THE GALVANIZED IRON OR STEEL THREADED TYPE.
- B. PYC CONDUIT (FOR ABOYE GROUND OR UNDERGROUND MORK) SHALL CONFORM TO UL STANDARD 65 1 AND THE REQUIREMENTS OF NEC. PARAGRAPH 352. CONDUIT SHALL BE HEAVY WALL TYPE, SCHEDULE 40 OR 80, AND SUNLIGHT RESISTANT, FITTINGS SHALL BE OF THE UNTHREADED SOLVENT CEMENT TYPE
- C. EMT CONDUIT (FOR EXPOSED AND CONCEALED WORK): ELECTRIC METALLIC TUBING SHALL CONFORM TO ANSI C80.3 AND THE REQUIREMENTS OF NEC. PARAGRAPH 358 AND BE PROTECTED FROM CORROSION SUITABLE FOR THE ENVIORMENT IN WHICH THEY ARE TO BE INSTALLED. COUPLINGS AND CONNECTORS SHALL BE MADE UP TIGHT AND WHERE INSTALLED IN MET LOCATIONS SHALL COMPLY WITH NEC PARAGRAPH 3 14.15.
- 2. MINIMUM CONDUIT SIZE SHALL BE 3/4-INCH, SIZES NOT SHOWN ON DRAWINGS SHALL BE PER THE LATEST EDITION OF THE NEC.
- 3. ALL SPARE CONDUITS SHALL HAVE A METALLIC PULL WIRE.
- 4. CONDUIT SUPPORTS SHALL BE FURNISHED AND INSTALLED BY THE ELECTRICAL CONTRACTOR AND IN ACCORDANCE WITH THE LATEST EDITION OF THE NEC.
- 5. UNDERGROUND CONDUITS:
- A. INSTALL MARNING TAPE TWELVE INCHES ABOVE EACH CONDUIT OR SET OF CONDUITS. B. IDENTIFY EACH CONDUIT AT BOTH ENDS.
- C. INSTALL A MINIMUM OF 36 INCHES BELOW THE FINISHED GRADE, OR DEEPER IF NOTED ON PLAN DRAWINGS.
- D. SLOPE A MINIMUM OF 4 INCHES PER 100 FEET TO DRAIN AWAY FROM BUILDINGS AND EQUIPMENT.
- E. USE MANUFACTURED ELECTRICAL PVC ELBOWS AND FITTINGS FOR BELOW GRADE BENDS.
- F. MAKE JOINTS AND FITTINGS WATERTIGHT ACCORDING TO MANUFACTURER'S INSTRUCTIONS.
- G. INSTALL A COUPLING BEFORE EACH WALL PENETRATION.
- H. RESTORE SURFACE FEATURES DISTURBED BY EXCAVATION (AND TRENCHING) IN ALL AREAS.

CABLE TRAYS:

- 1. ALL CABLE TRAYS AND FITTINGS SHALL BE DESIGNED, MANUFACTURED, INSTALLED AND TESTED IN CONFORMANCE WITH NEMA VE 1 AND VE 2.
- 2. CABLE TRAYS SHALL BE LADDER TYPE WITH 9-INCH SPACING.
- 3. CABLE TRAYS SHALL BE CAPABLE OF SUPPORTING 75 LBS/LINEAR FOOT.
- 4. CABLE TRAYS AND FITTINGS SHALL BE MANUFACTURED OF GALVANIZED STEEL
- 5. CABLE TRAYS SHALL BE FURNISHED WITH COVERS WHERE SHOWN ON THE PROJECT DWG'S.
- 6. ALL DISCONTINUOUS SECTIONS OF CABLE TRAY SHALL BE BONDED ACROSS JOINTS.

CONDUCTORS:

- 1. ALL POWER, CONTROL AND COMMUNICATION WIRING SHALL MEET NEMA WC, ASTM, UL, AND NEC STANDARDS FOR MATERIAL AND WORKMANSHIP UNLESS OTHERWISE SPECIFIED.
- A. SERVICE ENTRANCE CONDUCTORS SHALL BE COPPER, 600 VOLT, SUNLIGHT RESISTANT, SUITABLE FOR MET LOCATIONS, TYPE USE-2. THE GROUNDED NEUTRAL CONDUCTOR SHALL BE IDENTIFIED WITH A WHITE MARKING AT EACH TERMINATION.
- B. CONDUCTORS FOR FEEDER AND BRANCH CIRCUITS SHALL BE COPPER, 600 YOLT, TYPE THHN/THWN WITH A MINIMUM SIZE OF #12 AWG.
- 2. ALL CONDUCTOR ACCESSORIES INCLUDING CONNECTORS, TERMINATIONS, INSULATING MATERIALS, SUPPORT GRIPS, MARKER AND CABLE TIES SHALL BE FURNISHED AND INSTALLED. SUPPLIER'S INSTALLATION INSTRUCTIONS SHALL BE OBTAINED FOR CABLE ACCESSORIES. THESE INSTRUCTIONS SHALL BE IN THE POSSESSION OF THE CRAFTSMAN WHILE INSTALLING THE ACCESSORIES AND SHALL BE AVAILABLE TO THE COMPANY FOR REFERENCE
- 3. WHERE POSSIBLE, #6 AMG AND SMALLER WIRE SHALL BE COLOR CODED BY THE COLOR OF THE INSULATION COVERING. COLOR CODING OF WIRE LARGER THAN #6 AWG MAY BE BY MEANS OF SELF-ADHESIVE WRAP-AROUND TYPE MARKERS. PER NEC.
- 4 TERMINAL CONNECTORS FOR CONDUCTORS SMALLER THAN #8 AWG SHALL BE COMPRESSION TYPE CONNECTORS SIZED FOR THE CONDUCTOR AND THE TERMINAL. THE CONNECTORS SHALL BE CONSTRUCTED OF FINE GRADE HIGH CONDUCTIVITY COPPER IN ACCORDANCE WITH FEDERAL SPECIFICATION QQ-C-576 AND SHALL BE TIN-PLATED IN ACCORDANCE WITH MILITARY PLATING SPECIFICATION MIL-T-10727. THE INTERIOR SURFACE OF THE CONNECTOR WIRE BARREL SHALL BE SERRATED AND THE EXTERIOR SURFACE OF THE CONNECTOR WIRE BARREL SHALL BE PROVIDED WITH CRIMP GUIDES.
- 5. TERMINAL CONNECTORS FOR CONDUCTORS #8 AWG AND LARGER SHALL BE PRESSURE OR BOLTED CLAMP, TYPE BURNDY, QUICKLUG, VARILUG OR ACCEPTABLE EQUAL, OR COMPRESSION, TYPE BURNDY TYPE YAY OR YA (LONG BARREL), PANDUIT TYPE LCA OR LCC, OR ACCEPTABLE EQUAL. ACCEPTABLE CONNECTORS INCLUDED WITH COMPANY FURNISHED EQUIPMENT MAY BE USED.
- 6. TERMINATION PROVISIONS OF EQUIPMENT FOR CIRCUITS RATED 100 AMPERES OR LESS, OR MARKED FOR NOS. 14 THROUGH 1 CONDUCTORS, SHALL BE USED ONLY FOR CONDUCTORS RATED 60°C (140°F). CONDUCTORS WITH HIGHER TEMPERATURE RATINGS SHALL BE PERMITTED, PROVIDED THE AMPACITY OF EACH CONDUCTOR IS DETERMINED BASED ON THE 60°C (140°F) AMPACITY OF THE CONDUCTOR SIZE USED.
- 7. TERMINATION PROVISIONS OF EQUIPMENT FOR CIRCUITS RATED OVER 100 AMPERES, OR MARKED FOR CONDUCTORS LARGER THAN NO. 1, SHALL BE USED ONLY FOR CONDUCTORS RATED 75°C (167°F). CONDUCTORS WITH HIGHER TEMPERATURE RATINGS SHALL BE PERMITTED, PROVIDED THE AMPACITY OF EACH CONDUCTOR IS DETERMINED BASED ON THE 75°C (167°F) AMPACITY OF THE CONDUCTOR SIZE USED.
- 8. ALL 600 VOLT OR LESS WIRING, WHERE COMPRESSION TYPE CONNECTORS ARE USED, SHALL BE INSULATED MITH AT LEAST ONE TURN OF "SCOTCHFILL" ELECTRICAL INSULATING PUTTY AND THEN COVERED WITH TWO HALF TURNS OF TAPE SIMILAR TO 3M COMPANY'S "33 PLUS" (33+) PLASTIC TAPE OR 88 OUTDOOR.

GROUNDING:

- 1. ALL BASE TRANSCEIVER SITE EQUIPMENT SHALL BE GROUNDED IN ACCORDANCE WITH THE LATEST EDITION OF THE NATIONAL ELECTRICAL CODE (NEC). THE LATEST EDITION OF LIGHTNING PROTECTION CODE NFPA 780 AND MANUFACTURERS SPECIFICATIONS.
- 2. THE ELECTRICAL SERVICE TO THE SITE SHALL BE GROUNDED AT THE SERVICE DISCONNECTING MEANS REQUIRED IN ARTICLE 250 OF THE NATIONAL ELECTRICAL CODE, AND IN ACCORDANCE WITH ANY LOCAL CODE.
- 3. ALL UNDERGROUND (BELOW GRADE) GROUNDING CONNECTIONS SHALL BE MADE BY THE CADWELD PROCESS (MECHANICAL LUG ATTACHMENTS BELOW GRADE ARE NOT ACCEPTABLE). CONNECTIONS SHALL INCLUDE ALL CABLE TO CABLE SPLICES (TEES, XS. ETC.), ALL CABLE CONNECTIONS TO GROUND RODS, GROUND ROD SPLICES, AND LIGHTNING PROTECTION SYSTEM AS INDICATED. ALL MATERIALS USED (MOLDS, WELDING METAL, TOOLS, ETC.) SHALL BE BY CADWELD AND INSTALLED PER MANUFACTURER'S RECOMMENDATION AND PROCEDURES.
- 4. ALL GROUNDING AND BONDING CONDUCTORS THAT ARE CONNECTED ABOVE GRADE OR INTERIOR TO A BUILDING SHALL BE CONNECTED USING TWO HOLED CRIMP TYPE (COMPRESSION) CONNECTIONS FOR #2 & #6 AMG INSULATED COPPER CONDUCTORS.
- 5. ALL GROUNDING CONNECTIONS INTERIOR AND EXTERIOR MADE THROUGHOUT THIS DOCUMENT SHALL BE MADE USING AN ANTI-OXIDATION COMPOUND. THE ANTI-OXIDATION COMPOUND SHALL BE THOMAS AND BETTS KOPR-SHIELD (TM OF JET LUBE INC.), OR BURNDY PENETROX -E. NO SUBSTITUTIONS. COAT ALL WIRES BEFORE LUGGING. COAT ALL SURFACES BEFORE CONNECTING.
- 6. ALL CONNECTIONS SHALL BE MADE TO BARE METAL. ALL PAINTED SURFACES SHALL BE FIELD INSPECTED AND MODIFIED TO ENSURE PROPER CONTACT. PRIOR TO CADWELD, GALVANIZING SHALL BE REMOVED BY GRINDING SURFACE TO BARE METAL. "SLAG" FROM CADWELD MUST BE REMOVED AND WELD SHALL BE SPRAYED WITH COLD GALVANIZE AFTER COMPLETION.
- 7. FERROUS METAL CLIPS WHICH COMPLETELY SURROUND THE GROUNDING CONDUCTOR SHALL NOT BE USED. CLIPS OF THE FOLLOWING MATERIALS AND TYPES MAY BE USED TO SUPPORT GROUNDING CONDUCTORS.
 - PLASTIC CLIPS
 - STAINLESS STEEL CLIPS WHICH DO NOT COMPLETELY SURROUND THE GROUNDING CONDUCTOR
 - FERROUS METAL CLIPS WHICH DO NOT COMPLETELY SURROUND THE GROUNDING CONDUCTOR

- 8. ALL BELOW GRADE GROUNDING CONDUCTORS SHALL BE BARE TINNED SOLID COPPER WIRE. ABOVE-GRADE GROUNDING CONDUCTORS MAY BE EITHER:
- BARE TINNED SOLID COPPER WIRE

ON THE DRAWINGS.

- THWN-INSULATED, CONTINUOUS GREEN COLOR, SOLID COPPER WIRE
- THWN-INSULATED, CONTINUOUS GREEN COLOR, STRANDED COPPER WIRE
- AS SPECIFIED ON THE GROUNDING DRAWINGS.
- A. UNDERGROUND GROUND RING SHALL BE A #2 AWG BARE TINNED SOLID COPPER WIRE
- B. #2 AMG WIRE SHALL BE STRANDED COPPER WITH GREEN THWN INSULATION SUITABLE FOR MET INSTALLATION (SOME ABOVE GROUND APPLICATIONS, I.E. INDOOR GROUND RING).
- C. #4/0 AMG WIRE SHALL BE STRANDED COPPER WITH GREEN THWN INSULATION SUITABLE FOR WET LOCATIONS (I.E., TO MAIN GROUND, BUILDING STEEL, BETWEEN GROUND BARS,
- LIGHTNING PROTECTION, MAIN WATER LINE OF THE BUILDING OR EXISTING GROUND ROD). D. #2 AMG MIRE SHALL BE BARE TINNED SOLID COPPER. ALL BURIED MIRE SHALL MEET THIS CRITERIA, INCLUDING CABLE TRAY GROUNDING WIRES AND OTHER WIRES AS INDICATED
- E. FENCE GATE BONDING JUMPER SHALL BE 4/0 WELDING CABLE THAT HAS BEEN CRIMPED ON EACH END WITH A CAP FOR THE CADWELD PROCESS.
- F. THE MINIMUM BEND RADIUS IS 8 INCHES FOR #6 AMG AND SMALLER; 12 INCHES FOR WIRE LARGER THAN #6 AMG.
- 9. ALL HARDWARE, BOLTS, NUTS, WASHERS AND LOCK WASHERS SHALL BE 18-8 STAINLESS STEEL. EVERY CONNECTION SHALL BE BOLT-FLAT WASHER-BUSS-LUG-FLAT MASHER-LOCK MASHER-NUT IN THAT EXACT ORDER, WITH NUT FACING OUTWARD. BACK-TO-BACK LUGGING, BOLT-FLAT WASHER-LUG-FLAT WASHER-BUSS-LUG-LOCK WASHER-NUT, IN THAT EXACT ORDER IS ACCEPTED WHERE NECESSARY TO CONNECT MANY LUGS TO A BUSS BAR. STACKING OF LUGS, BUSS-LUG-LUG, IS NOT ACCEPTABLE.
- 10. COMPRESSION GROUND LUGS FOR GROUNDING CONDUCTORS SHALL BE BURNDY TYPE YAXX-2TC38 OR APPROVED EQUAL.
- 11. THE DEPTH OF THE GROUND RING, WHEN SPECIFIED, SHALL BE EITHER 3'-6" BELOW FINAL GRADE OR IT SHALL BE INSTALLED TO THE MINIMUM DEPTH REQUIRED BY LOCALLY ENFORCED CODES, REGULATIONS AND ORDINANCES, WHICHEVER IS DEEPER.
- 12. THE GROUND RING, WHEN SPECIFIED, SHALL BE A MINIMUM OF 24 INCHES FROM THE EQUIPMENT SHELTER FOUNDATION, PLATFORM OR CONCRETE PAD.
- 13. GROUND RODS, WHEN SPECIFIED, SHALL BE 5/8 INCH STEEL, CLAD WITH A PURE COPPER JACKET OF NOT LESS THAN 0.0012 INCHES THICK, 8 FEET LONG (MIN.), GROUND RODS SHALL BE DRIVEN TO THE FULL VERTICAL LENGTH IN UNDISTURBED EARTH.
- 14. SPACING BETWEEN GROUND RODS, WHEN SPECIFIED, SHALL BE A MINIMUM OF 6 FEET PER THE NATIONAL ELECTRICAL CODE.
- 15. XIT RODS, WHEN SPECIFIED, SHALL BE MIN. 2" ID TYPE "K" COPPER TUBE MITH A MINIMUM WALL THICKNESS OF 0.083" AND SHALL BE A MINIMUM OF 8 FEET IN LENGTH. THE XIT COPPER PIPE/ ROD SHALL BE FILLED WITH NON-HAZARDOUS METALLIC SALTS. THE BACKFILL MATERIAL SHALL BE NATURAL CLAY LYNCONITE II. THE COVER SHALL BE FIBERLYTE CAST IRON. LYNCOLE MODEL XB-12F, FOR LIGHT TRAFFIC AREAS, XB-12 FOR MEDIUM TRAFFIC AREAS AND XB-22, FOR HEAVY TRAFFIC OR PAVED AREAS.
- 16. PPC BONDING. PPC UNITS ARE SHIPPED WITH A NEUTRAL-GROUND BONDING JUMPER INSTALLED (SERVICE ENTRANCE RATED). AT SITES WHERE THE PPC IS NOT SERVICE ENTRANCE RATED EQUIPMENT (AS DEFINED BY THE NEC), THIS BONDING JUMPER SHALL BE REMOVED.
- NOTE: AT SITES WHERE THE PPC IS NOT SERVICE ENTRANCE RATED EQUIPMENT, THE CONTRACTOR SHALL VERIFY THAT THE SERVICE ENTRANCE NEUTRAL IS GROUNDED PRIOR TO REMOVAL OF THE BONDING JUMPER IN THE PPC.
- 17. THE ANTENNA CABLES SHALL BE GROUNDED AT THE TOP AND BOTTOM OF THE VERTICAL RUN. THE ANTENNA CABLE SHIELD SHALL BE BONDED TO A COPPER GROUND BUS AT THE LOWEST POINT OF VERTICAL RUN. THE ANTENNA CABLE SHIELD SHALL BE GROUNDED JUST BEFORE ENTERING THE BTS CABINET. GROUNDING KITS ON COAX CABLE SHALL HAVE A MINIMUM BEND OF 6" AND SHALL BE KEPT AS CLOSE TO VERTICAL AS POSSIBLE. FLAT WASHER SENT WITH GROUND KITS MUST BE REPLACED WITH SMALLER STAINLESS FLAT WASHERS. WASHERS MUST REMAIN FLAT AGAINST GROUND BAR. ALL FASTENERS MUST BE STAINLESS STEEL AND KOPR-SHIELD MUST BE USED ON BOTH SIDES OF GROUND BAR.

LIGHTNING PROTECTION:

1. LIGHTNING PROTECTION MATERIALS SHALL BE FURNISHED BY THE OWNER AND INSTALLED BY CONTRACTOR.

GROUND SYSTEM TESTING:

- 1. A RESISTANCE-TO-GROUND OF 3 OHMS OR LESS IS THE OBJECTIVE OF THE EXTERNAL GROUND SYSTEM. THE CONTRACTOR SHALL PERFORM TESTS AS SPECIFIED IN THE OWNERS STANDARDS - SITE RESISTANCE TO EARTH TESTING TO DETERMINE RESISTANCE-TO-GROUND OF THE COMPLETED EXTERNAL GROUND SYSTEM. TEST SHALL BE PERFORMED PRIOR TO BACKFILLING TRENCHES. THE CONTRACTOR SHALL EMPLOY THE SERVICES OF AN EXPERIENCED TESTING LABORATORY OR ENGINEERING FIRM FAMILIAR WITH THE SPECIFIED TEST METHOD. IF RESISTANCE OF THE ENTIRE SYSTEM EXCEEDS 10 OHMS NOTIFY THE OWNER'S REPRESENTATIVE FOR FURTHER DIRECTION.
- 2. GROUND RESISTANCE SHALL BE MEASURED FOR EACH PIECE OF EQUIPMENT TO THE GROUND ELECTRODE.
- 3. GROUNDING RESISTANCE TEST REPORT: A GROUNDING RESISTANCE TEST REPORT SHALL BE PREPARED UPON COMPLETION OF THE TESTING FOR EACH SITE. THE TEST REPORT SHALL CONTAIN THE COMPLETED OWNERS FORMS AND SHOW THE RESISTANCE IN OHMS AT 62% SPACING AND WITH AUXILIARY POTENTIAL ELECTRODES AND READINGS AT 10% INTERVALS WITH A TOTAL DISTANCE OF AT LEAST 500 FEET OR UNTIL THE AVERAGE RESISTANCE STARTS INCREASING, IT SHALL CONTAIN 10 TO 15 PHOTOGRAPHS TAKEN DURING CONSTRUCTION TO PROVIDE PROOF THAT THE ENTIRE EXTERNAL GROUND RING SYSTEM WAS COMPLETE BEFORE BACKFILLING. THE CONTRACTOR SHALL ALSO NOTIFY THE OWNER NO LESS THAN 48 HOURS IN ADVANCE OF BACKFILL. TESTING SHALL BE COMPLETED BY THE CONTRACTOR AND TWO

NEW PAR dba



MARPER INGINEERING, INC. TELECOM GROUP

815 Superior Ave. Suite 1514 Cleveland, OH. 44114

Phone: (216)344-3855 Fax: (216)344-3856

DRAWING REVISIONS

	Rev.	Description:	Date:	M
	A	For Approval	04/25/14	DY
- ,	0	For Construction	08/12/14	DI
	1	For Construction	01/12/15	DI
		1		



Engineer's Seal

SITE NAME: MASSILLON DT II

> SITE NUMBER: CNTN-056

FINEFROCK ROAD SM MASSILLON, OH 44647

SHEET NAME:

GENERAL NOTES

SHEET No./Rev.:

CHK'D. BY: GJB DATE: 11/15/13 FILE: 9-149-078

SCALE: AS NOTED

DRWN. BY: MEP

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(2) COPIES OF THE GROUNDING RESISTANCE TEST REPORT ARE TO BE BOUND AND

SUBMITTED WITHIN 2 DAYS OF TEST COMPLETION FOR EACH SITE.

NOTICE TO CONTRACTOR - ENVIRONMENTAL CONDITIONS/RESTRICTIONS AT MASSILLON DT II / EBBROS LLC (CNTN-056)-OH

Note: Verizon Wireless makes no representation or warranty as to the accuracy or completeness of the information below. Company is fully responsible for its own compliance with all applicable laws and regulations. To the extent that Company becomes aware of any additional environmental conditions, it agrees to immediately inform Verizon Wireless.

The Company's response to this construction bid shall constitute the Company's acknowledgement and acceptance of the stated conditions and restrictions at the site.

The following environmental conditions have been identified at the project site:

En	vironmental Condition	Description and Location of Contaminant
	Check All That Apply	
X	Contaminated soil	Soils on site contain elevated levels of lead ranging from 654 ppm to 774 ppm (compared to Ohio EPA-VAP residential standard of 400 ppm). Soils with elevated levels of lead were encountered in EB-2 and EB-6 (see attached map for boring locations).
	Contaminated groundwater	
	Presence of asbestos	
	Presence of lead-based paint	
	Other:	

Applicable legal requirements or Verizon Wireless policies and procedures may require that these conditions be communicated to all parties involved in the construction activities at the project site. To the extent that the scope of the project work includes measures to address these conditions, details of the work to be performed shall be as specified in the project documents and/or the Authorization Letter.

Environmental conditions affecting scope of work:

(see project documents for detailed specifications)

All contractors and workers conducting work on this project must be notified of the possible presence of elevated levels of lead in the soils on site. All contractors and site workers should undertake all necessary and proper OSHA precautions while working in and around the soils and groundwater on site.

A **Soil Management Plan**, dated August 26, 2014 has been developed by VZW's environmental oversight consultant, CTL, for the site to address the potential for impacted soils. The **Soil Management Plan** shall be implemented and consulted for specific details as to plan implementation. CTL, the environmental oversight consultant, shall be notified at least two weeks in advance of excavation and construction so that the consultant can be mobilized to conduct the required work.

Environmental Oversight Consultant

Bipender Jindal CTL Engineering, Inc. 2860 Fisher Road Columbus, Ohio 43204 (614) 276-8123 jindalb@ctleng.com

Company is required to comply fully with all applicable environmental, industrial hygiene, and worker health and safety laws and regulations; Verizon Wireless' directions and/or instructions contained in this Notice To Contractors. Company shall retain qualified, appropriately specialized (and/or licensed,

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as required) and adequately insured_environmental firms for the completion of specialized work as applicable. Company shall evaluate whether a Health and Safety Plan (HASP) is warranted. Verizon Wireless shall have the final authority to approve the selection of such environmental firms performing services on its behalf.

The construction bid package shall include qualifications of proposed firms with respect to the following required services:

 All excavated soils must be handled and disposed of in accordance with CTL's S Management Plan, dated August 26, 2014. Pursuant to CTL's Soil Management Plan, all soils excavated as part of the development and construction of the proposed tower site and access path shall segregated and stockpiled for waste characterization prior to their reuse on-site disposal off-site. If the total lead concentration of analyzed soils from the stock soils is below Ohio EPA's Voluntary Action Program (VAP) residential land use scenario of 400 ppm, the soil may be reused on-site. If any soil samples exhibit concentrations above 400 ppm, the stockpiled soils must be disposed off-site at licensed solid waste landfill. CTL, the environmental oversight consultant, must be notified at least two (2) we advance of excavation and construction work so that the consultant can be mobito conduct the required work. Other: All contractors and workers conducting work on this project must be notified possible presence of elevated levels of lead in the soils on site, and that they should une all necessary and proper OSHA precautions while working in and around the soils on site. Company shall ensure at all times that only appropriately trained qualified, and licensed workers perform the required environmental services. It is the responsibility of Company to adhere to the following restrictions in response to the above environmental conditions: An outside environmental "oversight" consultant is required if transportation and disposal of 	soils excavated as part of the sed tower site and access path shall be erization prior to their reuse on-site or ion of analyzed soils from the stockpiled Program (VAP) residential land use on-site. If any soil samples exhibit leaded soils must be disposed off-site at a c, must be notified at least two (2) weeks
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wastes is carried out in accordance with applicable laws, regulations and the Verizon Wireless Environmental Compliance Program. THE USE OF SUCH CONSULTANT IS MANDATORY.	
Site Postrictions	
Check All That Apply	
Restrictions on excavations/construction methods. Description: In accordance with the	escription: In accordance with the So
Management Plan, all soils with total lead levels of 400 ppm or above must be taken offs	
disposed of in a licensed solid waste landfill.	
Diesel fuel is prohibited at the construction site, except in the fuel tank of the vehicle.	
Gasoline is prohibited at the construction site, except in the fuel tank of the vehicle.	he fuel tank of the vehicle.
Other:	
Contractor's Signature:	
Contractor's Signature: Print Name:	
Contractor's Signature: Print Name: Witness: Site Name: Magaillan DT II (Ehbres II C (CNTN 056)	
Contractor's Signature: Print Name: Witness: Site Name: Massillon DT II / Ebbros LLC (CNTN-056)	· · · · · · · · · · · · · · · · · · ·
Contractor's Signature: Print Name: Witness: Site Name: Magaillan DT II (Ehbres II C (CNTN 056))	

NEW PAR dba



HARPER

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Phone: (216)344-3855 Fax: (216)344-3856

DRAMING REVISIONS

Rev. Description:

Date: Mgr.

DAVID
W.
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Engineer's Seal

SITE NAME: MASSILLON DT II

SITE NUMBER: CNTN-056

FINEFROCK ROAD SW MASSILLON, OH 44647

SHEET NAME:

NOTICE TO CONTRACTOR

SHEET No./Rev.:

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DRWN. BY: MEP

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SCALE: AS NOTED