


SOUTH ELEVATION SCALE: 1/4" = 1'-0"

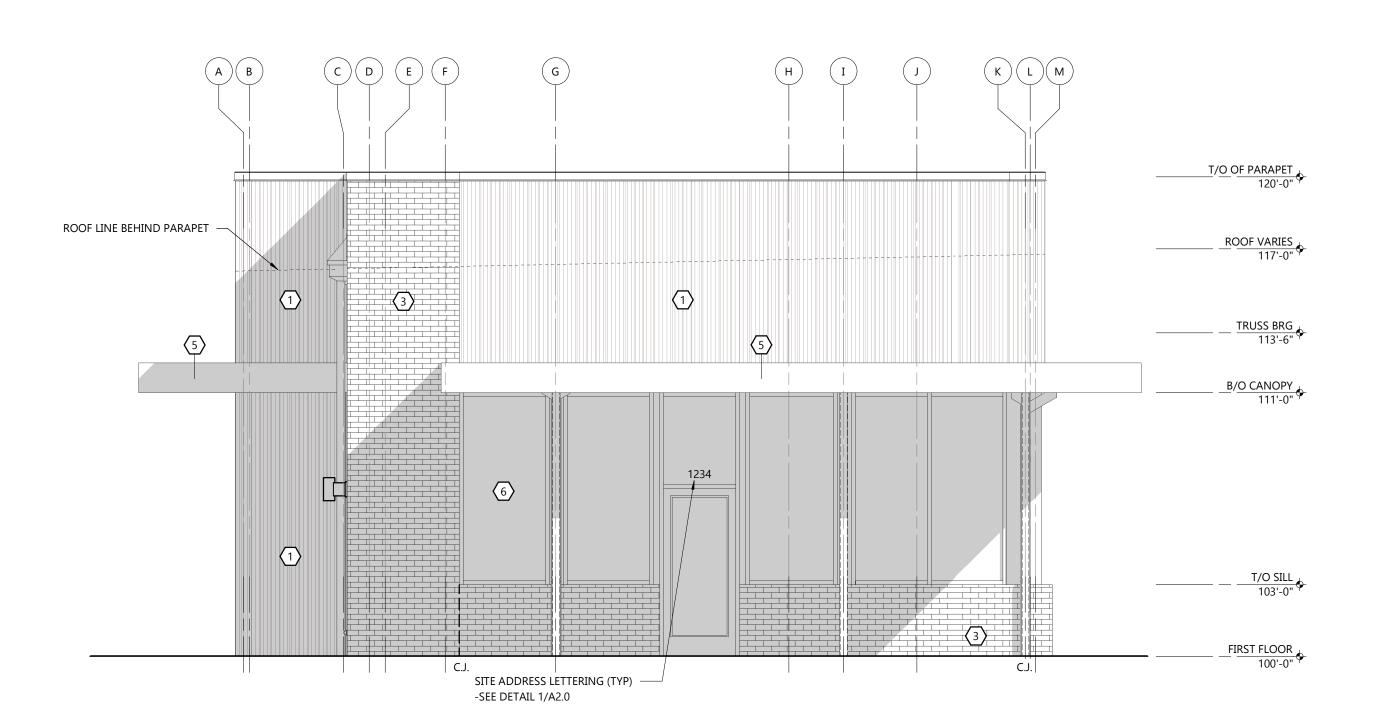

NORTH ELEVATION SCALE: 1/4" = 1'-0"

EXTERIOR SIGNAGE

- ALL EXTERIOR SIGNAGE IS BY TENANT AT TIME OF TENANT BUILD-OUT AS SEPARATE SUBMITTAL.
- PROVIDE 1/2" TREATED PLYWOOD SUBSTRATE OVER EXTERIOR WALL SHEATHING FOR SIGNAGE ATTACHMENT. (ADJUST THICKNESS OF RIGID INSULATION TO KEEP FINISH FACE OF EIFS FLUSH)
- COORDINATE SIGNAGE LOCATION w/ SIGNAGE SUPPLIER.

CONTROL JOINTS

- 'CJ' INDICATES THE LOCATION OF A MASONRY CONTROL / EXPANSION JOINT
- ALL MASONRY CONTROL JOINTS SHOWN AT CORNER CONDITIONS TO BE AT INSIDE CORNER

FOUNDATIONS

HAND RUB ALL EXPOSED CONCRETE FOUNDATIONS PER SPEC 03 30 00 F (SHEET A0.1) AND STAIN TO MATCH STONE

TYPICAL BACK OF PARAPET

SEAL ALL JOINTS PER MFR REQUIRMENTS TO MAINTAIN WARRANTY

- AT HIGH PARAPETS: 1. RUN ROOF MEMBRANE UP TO LEVEL OF LOW PARAPET
- 2. FLASH w/ SS TERMINATION BAR 3. RUN PVC MEMBRANE (COLOR TO MATCH EIFS) UP AND OVER PARAPET (SEE DETAILS)
- AT LOW PARAPETS: 1. ROOF MEMBRANE TO RUN CONTINUOUS OVER TOP OF PARAPET (SEE DETAILS)


EXTERIOR FINISH KEY

- PAINTED ELEMENT COLOR: PAINTED SW 7069 IRON ORE
- THERMALLY BROKEN ALUMINUM FRAME w/ INSULATED GLAZING COLOR: MATCH RAL#7021 MT0028 FLAT BLACK SEE A6 SHEET(s)
- METAL SEAM AWNING W/ ALUMINUM FRAME RAL MFR: LOCALLY SOURCED STYLE: POWDERCOAT COLOR: TO MATCH RAL#7021 MT0028 FLAT BLACK
- MFR: DRYVIT STYLE: TEXTURE W/ STRATOTONE COLORANT
- TEXTURE: SANDBLAST TEXTURE COLOR: TO MATCH SW 7030 ANEW GRAY MODULAR BRICK VENEER
- MFR: MUTUAL MATERIALS COLOR: PEWTER MISSION MORTAR: SM100 GRAY
- PRECAST CONCRETE SILL MFR: STONECAST COLOR: LIMESTONE MORTAR: WESTERN LIME CORP W-5
- VERTICAL WOOD SIDING PANEL MFR: IDENTITY WOOD PRODUCTS COLOR: PRETZEL MEDIUM BROWN STYLE: SEALED FACE AND BACK 5/8" X 7-1/4". ALUMINUM TRIM POWDER COATED TO MATCH CLADDING



STYLE TO MEET ALL STATE AND LOCAL CODES

1 ADDRESS DETAIL

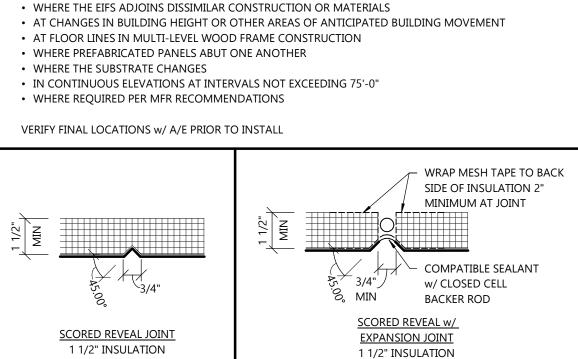

1 1/2" INSULATION THICKNESS OR GREATER THICKNESS OR GREATER SCORED REVEAL IS USED FOR VISUAL APPEARANCE ONLY AND DOES NOT ACT AS AN **EXPANSION JOINT**

EIFS EXPANSION JOINTS REQUIRED AT THE FOLLOWING LOCATIONS: WHERE THEY EXIST IN THE SUBSTRATE OR SUPPORT CONSTRUCTION

─ WRAP MESH TAPE TO BACK SIDE OF INSULATION 2" MINIMUM AT JOINT FOR REVEALS IN MATERIAL LESS THAN 1 1/2" THICK, COMPATIBLE SEALANT EXPANSION JOINTS OR MFR w/ CLOSED CELL APPROVED REVEAL TRIM BACKER ROD MUST BE USED **EXPANSION JOINT** LESS THAN 1 1/2" INSULATION THICKNESS

2 EIFS JOINT DETAILS
A2.0 SCALE: 3" = 1'-0"

2178020 SHEET NUMBER

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PROJECT INFORMATION

excelengineer.com

44646 Н

BUILDING SHELL

LINCOLN

PROFESSIONAL SEAL

PRELIMINARY DATES JAN. 20, 2023

JOB NUMBER