


3. PAGING CONTRACTOR SHALL COORDINATE ALL POWER SUPPLY TERMINATIONS AND REQUIREMENTS WITH EC PRIOR TO INSTALLATION.

WITH THE STRUCTURED CABLING SPECIFICATIONS AND SHALL MATCH SAME IN BOTH PERFORMANCE AND MANUFACTURER.

CUST OFFICE B-123

RISER DIAGRAM NOTES:

APPROVED DIAGRAM AND MANUFACTURER'S RECOMMENDATIONS.

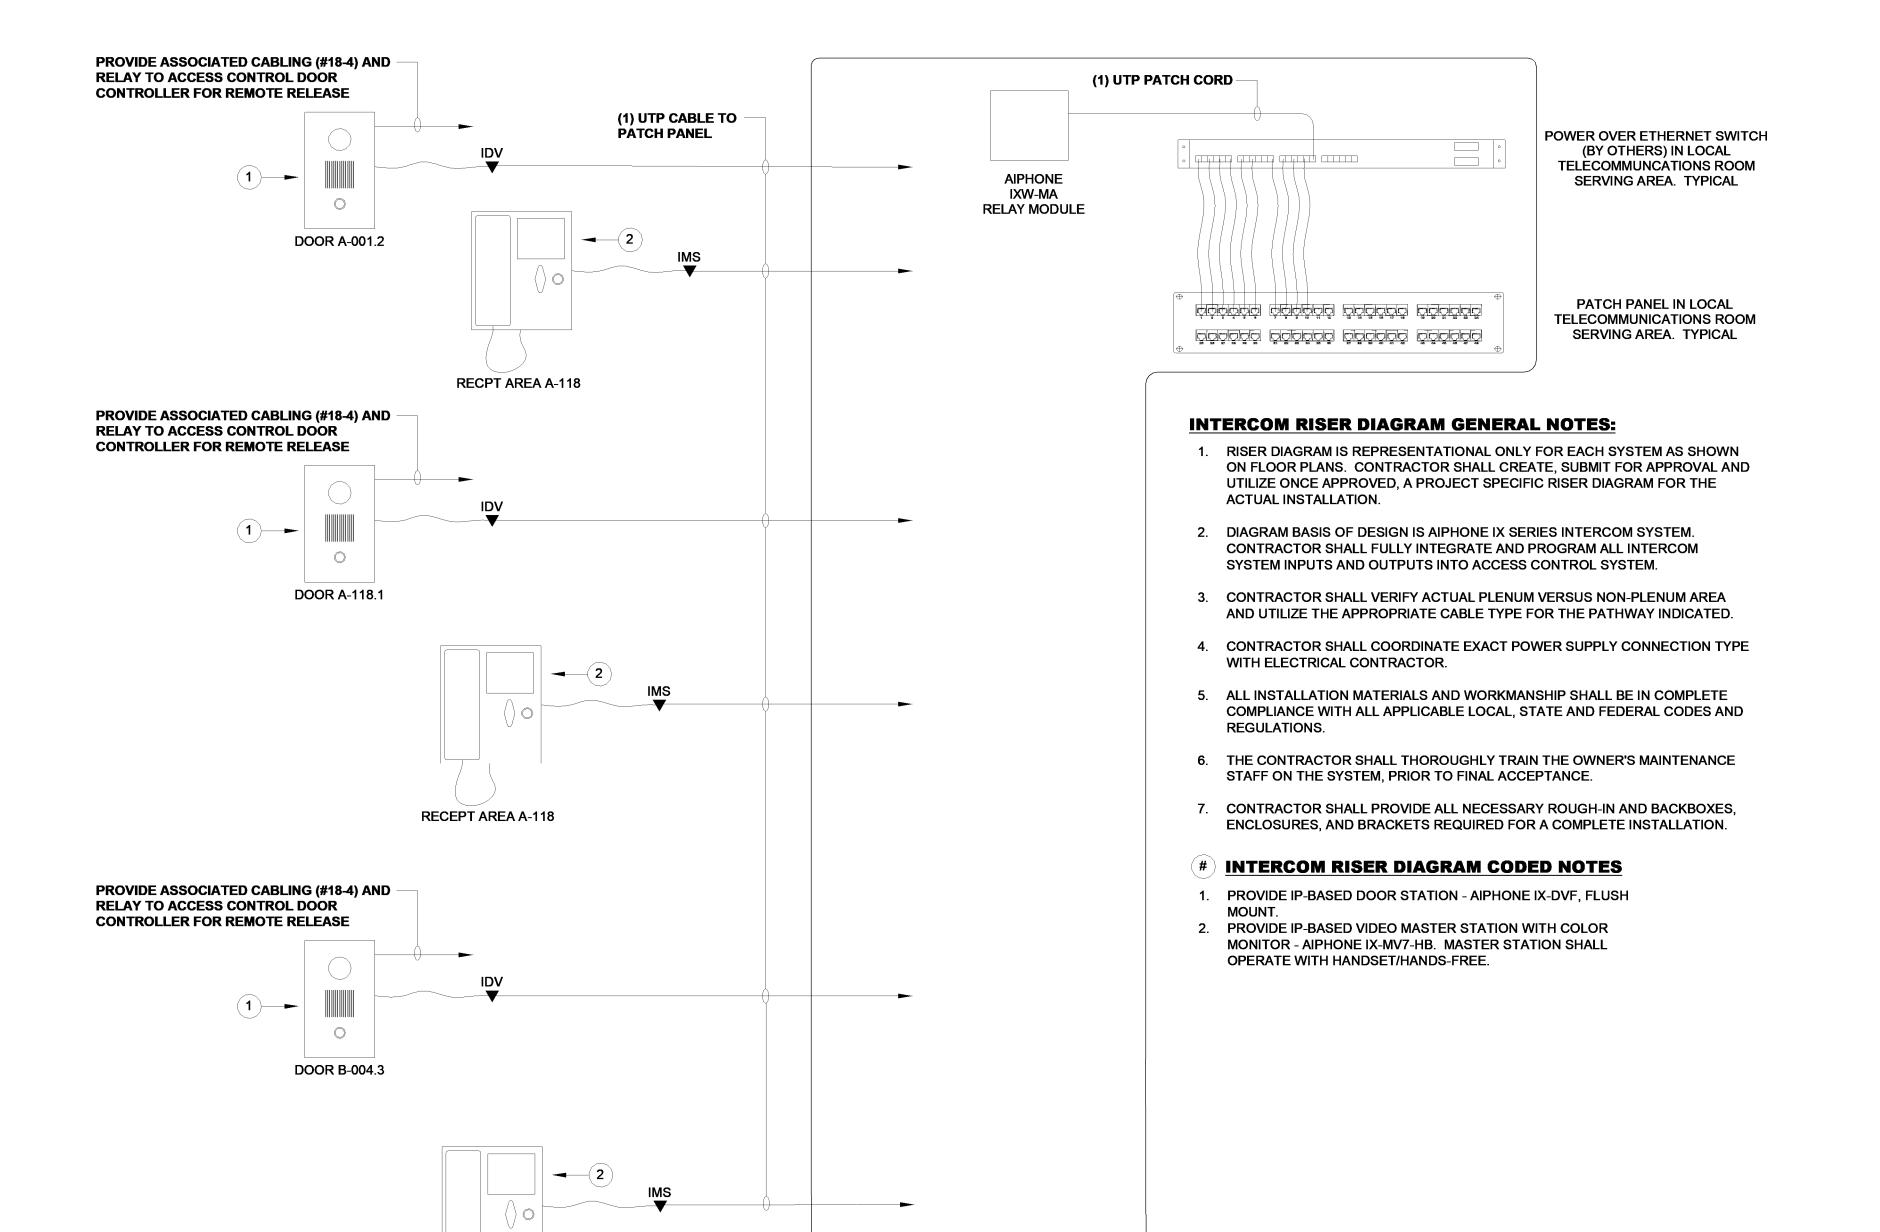

TYPICAL NEAREST TELECOM ROOM

1. DIAGRAM IS REPRESENTATIONAL ONLY. AUDIO VISUAL INTEGRATOR SHALL SUBMIT FOR APPROVAL A PROJECT SPECIFIC RISER DIAGRAM. DIAGRAM SHALL INCLUDE, BUT NOT LIMITED TO, ALL REQUIRED DEVICES AND CABLING. SYSTEM SHALL BE INSTALLED PER


4. PAGING CONTRACTOR SHALL PROVIDE ALL CABLING JUMPERS AND TERMINATIONS TO COMPLETE ALL INTERCONNECTIONS OF THE SYSTEM BOTH WITHIN AND EXTERNAL TO THIS SYSTEM. ALL NETWORK COPPER AND FIBER TERMINATIONS SHALL BE IN FULL COMPLIANCE

2. ALL INSTALLATION MATERIALS AND WORKMANSHIP SHALL BE IN COMPLETE COMPLIANCE WITH ALL APPLICABLE CODES AND REGULATIONS INCLUDING, BUT NOT LIMITED TO, NFPA 70 (NEC) AS WELL AS ALL ASSOCIATED INDUSTRY STANDARDS, E.G EIA/TIA 568.

PROJECT NO 2203-2

>

 $\mathbf{\Omega}$

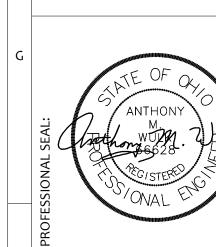





BICSI ID # 181837R Daniel R Kodicovic

PROJECT NO 2203-2

DRAWN BY DRK

TECHNOLOGY RISER DIAGRAMS

SCALE: 1/8" = 1'-0" T-602