


FLOORING LEGEND ALT 1

RUB-1	RUBBER TILE
RUB-2	RUBBER TILE
RUB-3	RUBBER TILE
RUB-4	RUBBER TILE
RUB-5	RUBBER TILE
RUB-6	RUBBER TILE
RUB-7	RUBBER TILE
RUB-8	RUBBER TILE
RUB-9	RUBBER TILE
RUB-10	RUBBER TILE

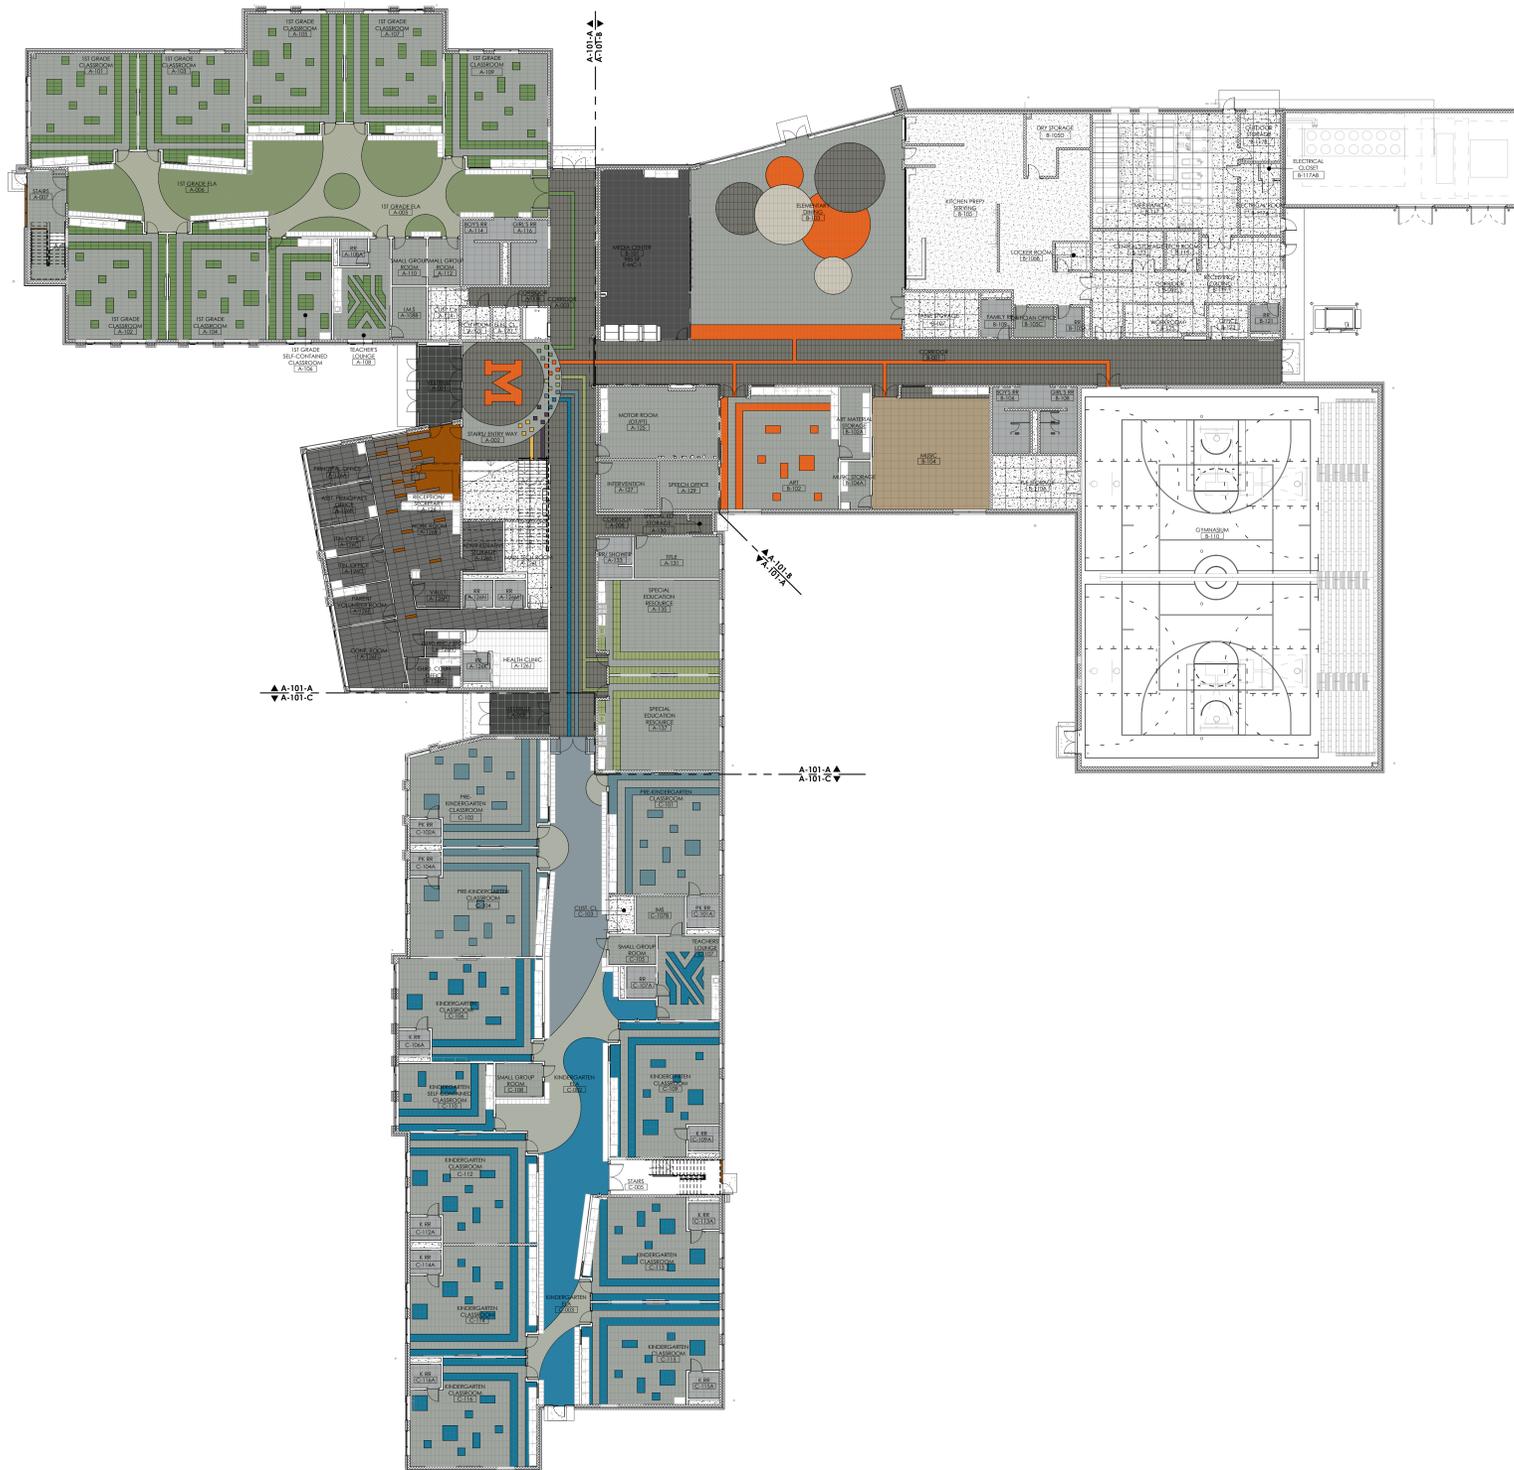


FLOORING LEGEND

LVT-1	LUXURY VINYL TILE
LVT-2	LUXURY VINYL TILE
LVT-3	LUXURY VINYL TILE
LVT-4	LUXURY VINYL TILE
LVT-5	LUXURY VINYL TILE
LVT-6	LUXURY VINYL TILE
LVT-7	LUXURY VINYL TILE
LVT-8	LUXURY VINYL TILE
LVT-9	LUXURY VINYL TILE
LVT-10	LUXURY VINYL TILE
CPT-1	CARPET TILE
CPT-2	CARPET TILE
CPT-3	CARPET TILE
CPT-4	CARPET TILE
CPT-5	CARPET TILE
CPT-6	CARPET TILE
LIN-1	LINOLEUM
LIN-2	LINOLEUM
LIN-3	LINOLEUM
LIN-4	LINOLEUM
LIN-5	LINOLEUM
LIN-6	LINOLEUM
LIN-7	LINOLEUM
LIN-8	LINOLEUM
PFT-1	PORCELAIN FLOOR TILE
CG	STAINLESS STEEL CORNER GUARD

- GENERAL FINISH NOTES
1. ALL LVT MUST BE PROVIDED BY SAME MANUFACTURER TO KEEP A CONSISTENT MATERIAL PATTERN.
 2. ALL LINOLEUM MUST BE PROVIDED BY SAME MANUFACTURER TO KEEP A CONSISTENT MATERIAL PATTERN.
 3. SEE INTERIOR ELEVATIONS FOR ACCENT WALL LOCATIONS.
 4. SEE RESTROOM PLANS AND ELEVATIONS FOR WALL TILE PATTERNS.
 5. SEE FINISH PLAN FOR FLOOR PATTERNS AND TRANSITION LOCATIONS.
 6. ALL EXPOSED SIDES OF WALL TILE TO BE FINISHED WITH 1-1 TRIM. SEE A-452.
 7. ALL PRODUCTS SHOWN ON MATERIAL SCHEDULE ARE SHOWN AS BASIS OF DESIGN. OTHER MANUFACTURERS THAT MEET SALES REQUIREMENTS MAY BE SUBSTITUTED PENDING ARCHITECT APPROVAL.
 8. SEE FINISH PLANS FOR SEALED CONCRETE CONTROL JOINTS.
 9. LINOLEUM SEAMS SHALL BE MET FIT SEAMS IN LIEU OF HEAT WELDED.
 10. SHOWER CLEARANCE MUST BE 36" MINIMUM FROM FINISH FACE TO FINISH FACE.
 11. PLUMBING FIXTURES AND RESTROOM ACCESSORIES MUST MAINTAIN ACCESSIBILITY REQUIREMENTS FROM FINISH DIMENSIONS.
 12. CONTRACTOR TO PROVIDE LOCKING BEHIND STUD WALLS WHERE CASEWORK, SHELVING, TECHNOLOGY, RESTROOM ACCESSORIES, ETC. IS MOUNTED.
 13. WOOD DOOR COLOR TO BE SELECTED BY ARCHITECT FROM MANUFACTURER'S FULL RANGE OF COLORS DURING SHOP DRAWING PHASE.
 14. HOLLOW METAL DOOR AND FRAME COLOR TO BE PFT-1 UNLESS NOTED OTHERWISE ON INTERIOR ELEVATIONS.
 15. CORNER GUARDS INDICATED ON FINISH PLAN AS CG.
 16. ALL FLOOR CONTROL JOINTS AS INDICATED ON FINISH PLAN ARE TO BE 1/4" DEPTH OF SLAB THICKNESS. IF JOINT IS GREATER THAN 1/2" DEEP, FILL WITH FOAM BACKER ROD 1/8" WIDER THAN JOINT. FILL ALL JOINTS WITH 100% SOLIDS EPOXY FILLER COLOR MATCHED TO CONCRETE.
 17. CONTRACTOR TO PROVIDE WALK OFF MATS AT ALL BUILDING ENTRANCES.
 18. SEE A-451 FOR FINISH SCHEDULE.
 19. SEE INTERIOR ELEVATIONS FOR CHYSUM CONTROL JOINT LOCATIONS. SEE A-452 FOR DETAIL.
 20. CONTINUE FINISH FLOOR UNDER OPEN CASEWORK, TYP.

KEY PLAN

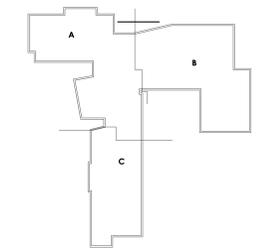

FIRST FLOOR FINISH PLAN (121,536 SF)
SCALE: 1/16" = 1'-0"
0' 8' 16' 32'

PROJECT NO
2203-1

ARCHITECTURAL VISION GROUP, LTD
ARCHITECTS & PLANNERS
23850 SPERRY DRIVE CLEVELAND, OHIO 44145



MASSILLON CITY SCHOOL
MASSILLON WEST ELEMENTARY
PK-3
250 29TH STREET NW, MASSILLON, OHIO 44646
MASSILLON CITY SCHOOL DISTRICT MASSILLON, OHIO

PROJECT NO	2203-1
DRAWN BY	
CHECKED BY	
DATE	

FIRST FLOOR
FINISH PLAN
SCALE: As Indicated
SHEET NO
A-940