CHECKED BY Checker

PROTECTION SYMBOLS AND A ABBREVIATIONS

SCALE: As indicated

1.1 - FIRE SUPPRESSION ABBREVIATIONS		
SYMBOL	DESCRIPTION	


1.1 - FIRE SUPPRESSION ABBREVIATIONS			
SYMBOL	DESCRIPTION		
"WG	INCHES WATER GAUGE		
AD	ACCESS DOOR		
BFF	BELOW FINISHED FLOOR		
ВНР	BRAKE HORSE POWER		
CI	CAST IRON		
CW	COLD WATER		
EC	ELECTRICAL CONTRACTOR		
EL	ELEVATION		
F	FIRE SUPPRESSION PIPING		
FD	FLOOR DRAIN		
FDV	FIRE DEPARTMENT VALVE		
FDVC	FIRE DEPARTMENT VALVE CABINET		
FEC	FIRE EXTINGUISHER CABINET		
FH	FIRE HYDRANT		
FHC	FIRE HOSE CABINET		
FP	FIRE PUMP		
FPC	FIRE SUPPRESSION CONTRACTOR		
FS	FLOW SWITCH		
FX	FIRE SUPPRESSION		
GC	GENERAL CONTRACTOR		
GPM	GALLONS PER MINUTE		
HP	HORSE POWER		
HR	HOUR		
INV	INVERT		
IW	INDIRECT WASTE		
LF	LINEAL FEET		
MAX	MAXIMUM		
MC	MECHANICAL CONTRACTOR		
MIN	MINIMUM		
MOCP	MANUFACTURER'S OVER CURRENT PROTECTION		
MOD	MOTOR OPERATED DAMPER		
NPSH	NET POSITIVE SUCTION HEAD		
Р	PUMP		
PC	PLUMBING CONTRACTOR		
PD	PUMP DISCHARGE		
PIV	POST INDICATOR VALVE		
PRV	PRESSURE REGULATING VALVE		
PSI	POUNDS PER SQUARE INCH		
PVC	POLYVINYL CHLORIDE		
RPM	REVOLUTIONS PER MINUTE		
SP	STANDPIPE PIPING		
SPR	SPRINKLER PIPING		
TS	TAMPER SWITCH		
WIV	WALL INDICATOR VALVE		
WPD	WATER PRESSURE DROP		
°F	DEGREES FAHRENHEIT		
Ø	DIAMETER		
ΔΡ	CHANGE IN PRESSURE		


<u>NOTES</u>

- 1.) THESE DRAWINGS SHALL BE USED AS A GUIDE TO PREPARE SHOP DRAWINGS AS SPECIFIED.
- 2.) PROVIDE A WET PIPE SPRINKLER SYSTEM TO BE BASED ON LATEST ENFORCED N.F.P.A.-13
- 3.) CONTRACTOR SHALL HYDRAULICALLY CALCULATE SYSTEM USING
- HAZARD CLASSIFICATION PER NFPA-13 AND DESIGN CRITERIA PER CODE. 4.) CONTRACTOR TO SUBMIT SHOP DRAWINGS FOR PIPING, VALVING,
- HEAD LOCATIONS, DENSITIES AND CALCULATIONS. 5.) ALL SYSTEMS TO MEET DESIGN REQUIREMENTS PER N.F.P.A.
- AND APPLICABLE FIRE PREVENTION BUREAUS. 6.) APPROVED SHOP DRAWINGS BY GOVERNING AGENCIES ARE TO
- BECOME CONTRACT DRAWINGS. 7.) CONTRACTOR IS TO COORDINATE PIPING SHOWN ON THESE PLANS
- WITH WORK OF OTHER TRADES. (HVAC, PLUMBING, AND LIGHTING)
- 8.) INSTALL SPRINKLER HEADS TO COORDINATE WITH ARCHITECTURAL REFLECTED CEILING PLAN.
- 9.) NEW PENDENT SPRINKLER HEADS TO BE SEMI-RECESSED TYPE WITH CHROME FINISH.
- 10.) UPRIGHT SPRINKLER HEADS TO BE BRASS TYPE. 11.) SEE SPECIFICATION SECTIONS FOR FIRE PROTECTION.
- 12.) SIZING OF BACKFLOW PREVENTOR, SPRINKLER RISERS, ETC. TO
- BE BY SPRINKLER CONTRACTOR DURING SHOP DRAWING PHASE. 13.) PROVIDE SPRINKLER HEADS FOR CANOPIES AS REQUIRED.
- 14.) ALL SPRINKLER PIPING IN STAGE AREA TO BE ABOVE BOTTOM OF STEEL.
- 15.) SPRINKLER SYSTEM TO BE INSTALLED BY A LICENSED FIRE SPRINKLER CONTRACTOR. 16) VERIFY LOCATION OF FIRE DEPARTMENT CONNECTION WITH FIRE DEPARTMENT.
- POST INDICATING VALVE -PRESSURE GAUGE —


FIRE PROTECTION LEGEND

FIRE LINE ————————————————————————————————————	—— F ———	
SPRINKLER PIPING ——————	SP	
ANTI-FREEZE PIPING	AFP	
DRY SPRINKLER PIPING ——————		
SPRINKLER SYSTEM TEST & DRAIN LINE -	SPTL	
ALARM LINE ————————		
DRAIN LINE		
SHUT-OFF VALVE ————————————————————————————————————	\longrightarrow	
DOUBLE CHECK VALVE ASSEMBLY		
ALADM CHECK VALVE	.	
FLOW ALARM ——————————————		F. <i>F</i>
FLOW ALARM ————————————————————————————————————		——— F.H
TAMPER SWITCH		——— т.s
FIRE HYDRANT ————————————————————————————————————		F.H
FIRE HOSE CABINET		F.H.C
FIRE EXTINGUISHER ——————		F.E
FIRE EXTINGUISHER CABINET —————		F.E.C
DRAIN VALVE		D.\
CONNECT TO EXISTING -		C.T.X
SPRINKLER HEADS		
PENDENT TYPE	<u> </u>	
UPRIGHT TYPE ————————————————————————————————————	<u> </u>	
CONCEALED TYPE		
PENDENT WITH WIRE GUARD ———		
SIDEWALL TYPE ———————		

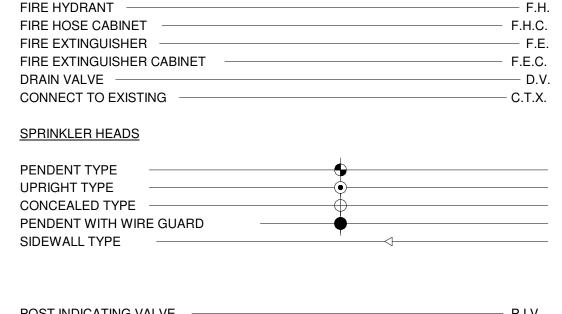

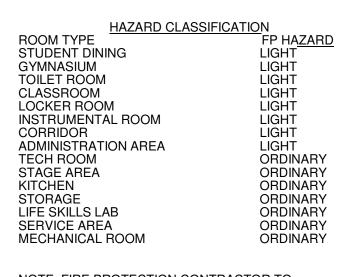

NOTE: FIRE PROTECTION CONTRACTOR TO VERIFY HAZARD CLASSIFICATION DURING SHOP DRAWING PROCESS.

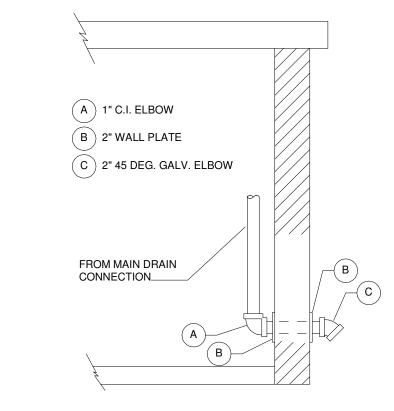

INDEX OF FIRE PROTECTION DRAWINGS

Sheet Name

FIRE PROTECTION SYMBOLS AND ABBREVIATIONS

FIRST FLOOR PLAN - FIRE PROTECTION - UNIT A

FIRST FLOOR PLAN - FIRE PROTECTION - UNIT B

FIRST FLOOR PLAN - FIRE PROTECTION - UNIT C

SECOND FLOOR PLAN - FIRE PROTECTION - UNIT A

SECOND FLOOR PLAN - FIRE PROTECTION - UNIT C

Sheet Number

FIRE PROTECTION: 6


FP-101-A

FP-101-B


FP-101-C

FP-102-A


FIRE RISER MAIN DRAIN DETAIL

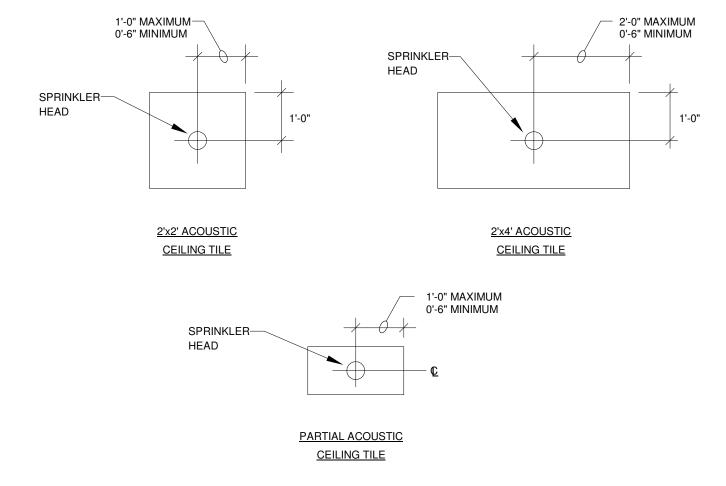

SPRINKLER HEAD LOCATION

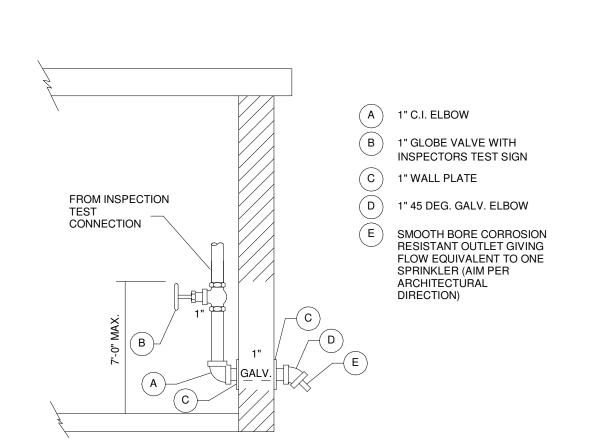

INSPECTORS TEST FOR WET PIPE SYSTEMS DETAIL

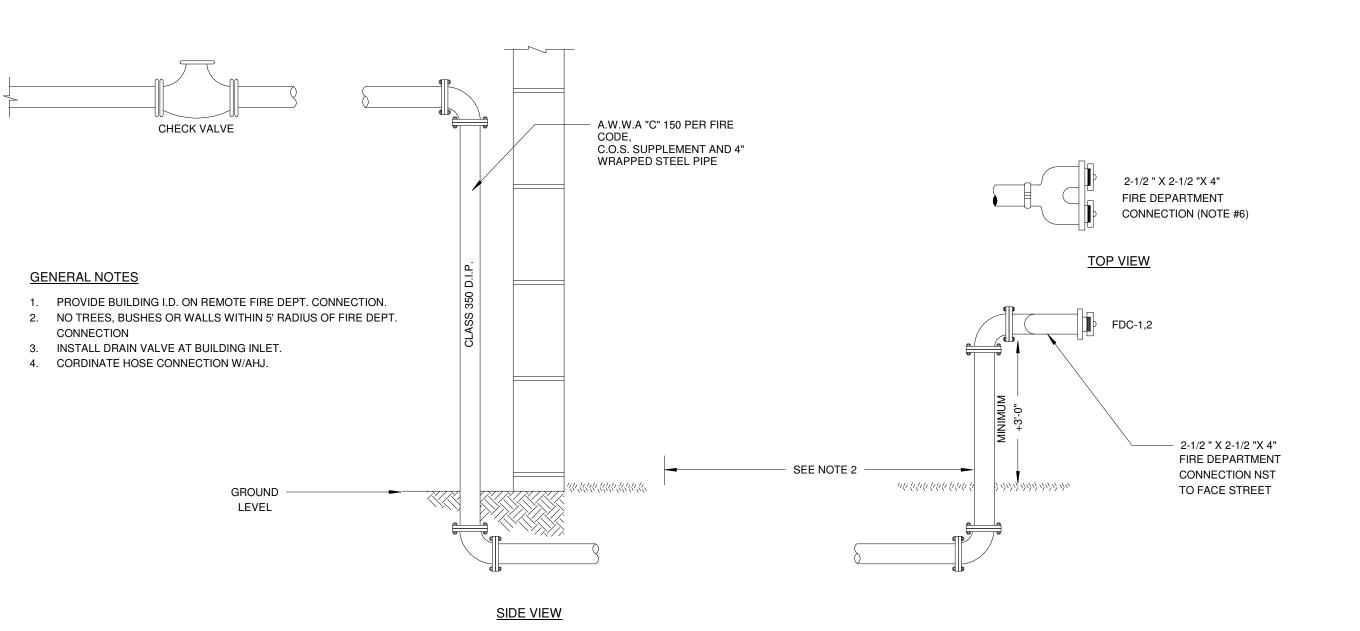

FIRE DEPARTMENT REMOTE SIAMESE CONNECTION DETAIL

- WET PIPE SPRINKLER RISER FLOW SWITCH WATER GONG TO FIRE DEPARTMENT CONNECTION SEE NOTE 1 - SPRINKLER CONTR. WORK BEGINS AT BLIND FLANGE SEE NOTE NO. 1 DRAIN VALVE 6" DOUBLE DETECTOR CHECK BFP. CONBRACO SERIES DCDA - FIRE LINE BY PLUMBING CONTR. FINAL CONNECTION BY— F.P. CONTRACTOR

CHANGE IN TEMPERATURE

FIRE LINE RISER SCHEMATIC

SPRINKLER CONTRACTOR TO DETERMINE SIZES OF BFP, RISERS, AND PIPING.