1/2" DIA HANGER RODS WITH 36" MAX SPACING ON EACH CHANNEL

1-5/8" 12 GAGE CHANNEL OR 2"X2"X1/4" ANGLE

PROJECT NO 2203-1 DRAWN BY MAR CHECKED BY ARB


HVAC DETAILS

SCALE: 1/8" = 1'-0"

- 1-1/2" THICK FIBERGLASS INSULATION W/ FOIL FACING EXPANDED TAKE-OFF GALVANIZED ROUND ELBOW MAIN OR BRANCH — DUCT METAL STRAP CLAMP (TYPICAL) 2 PLACES INSULATED FLEXIBLE CONNECTION IN VOLUME DAMPER ——— VERTICAL ONLY (MAX 5') FLEXIBLE DUCT DEFLECTION IN
DROP SHALL BE NO GREATER THAN
D/8 WHERE "D" IS THE FLEX DUCT DIAMETER


— SUPPLY AIR DIFFUSER

DIFFUSER CONNECTION - FLEX DETAIL NOT TO SCALE

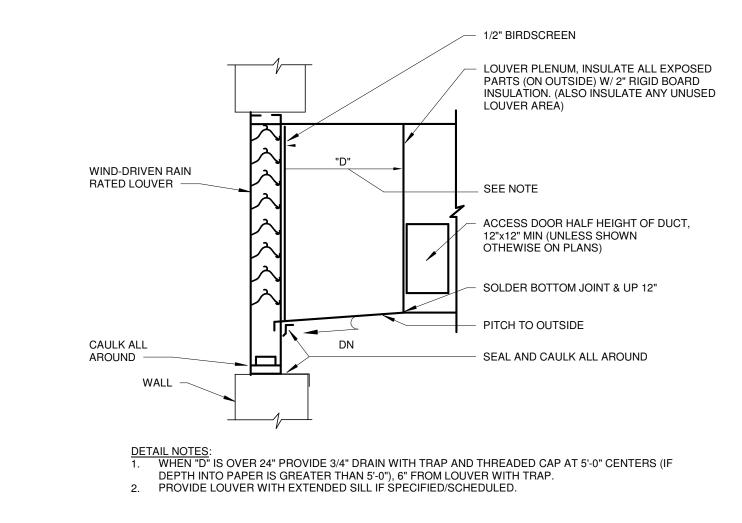

DIFFUSER BACKPAN INSULATION -



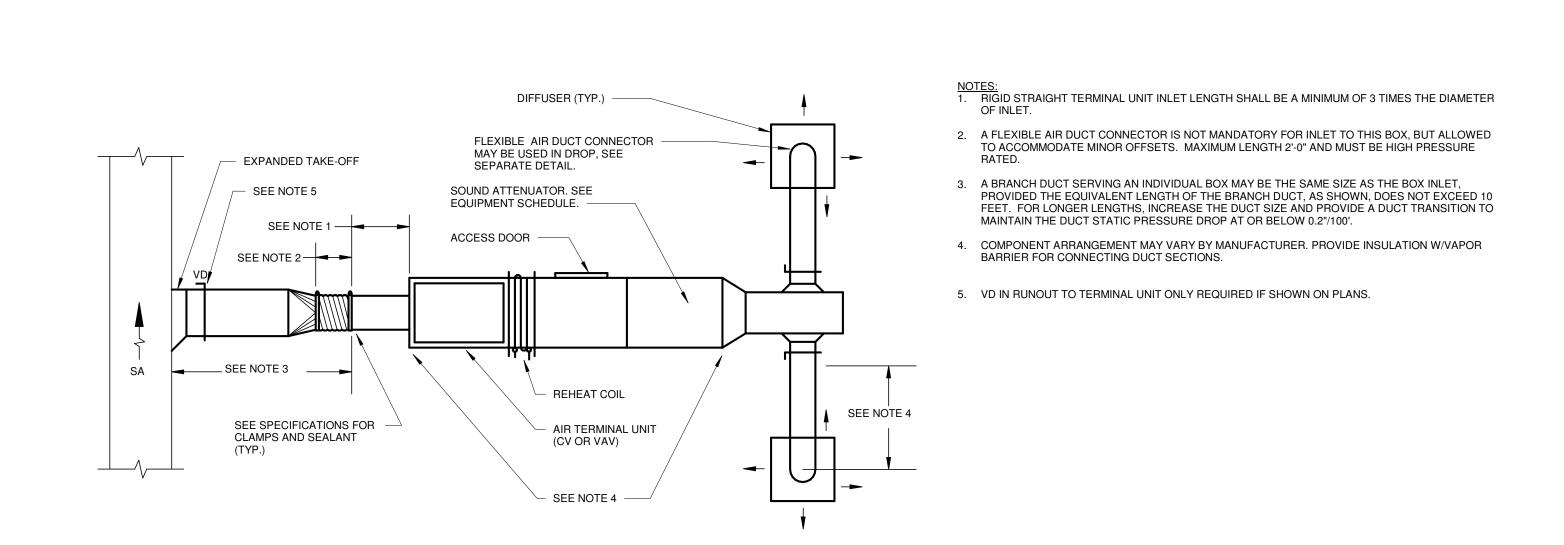

RECTANGULAR DUCT -THRU ROOF

18 GA. GALV. STEEL — SLEEVE

RECTANGULAR DUCT

FLASHING AND COUNTER

FLASHING OVER SLEEVE AND CURB, SECURE AND SEAL WEATHER-TIGHT.

INSULATED CURB

4"x4"x5/16" ANGLE FRAME AROUND

COORDINATE OPENING SIZES W/


OPENING. ALL WELDED CONSTRUCTION (TYP.)

DUCTWORK ROOF PENTRATION DETAIL

NOT TO SCALE


- 18 GA GALV. STEEL




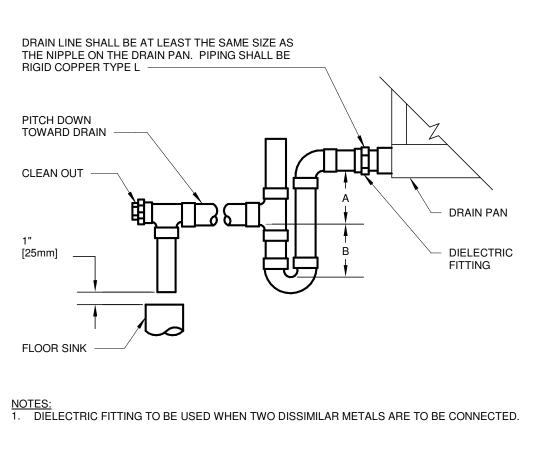


UNIT TYPE	Α	В
DRAW THRU	2" [50mm] PLUS X	Х
BLOW THRU	1" [25mm] MINIMUM	2X
WHERE X = STATION	C PRESSURE IN PAN	

CONDENSATE DRAIN TRAP NOT TO SCALE

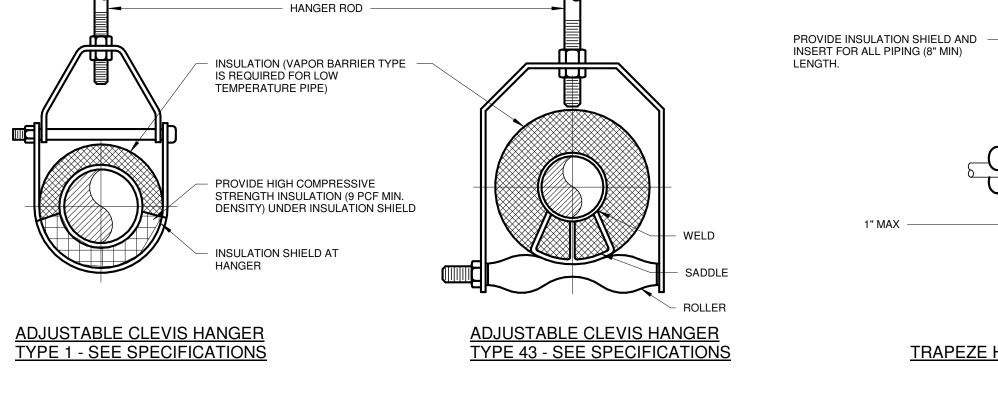


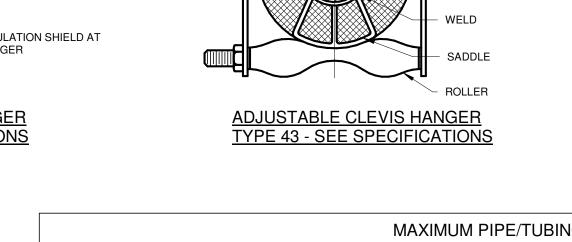

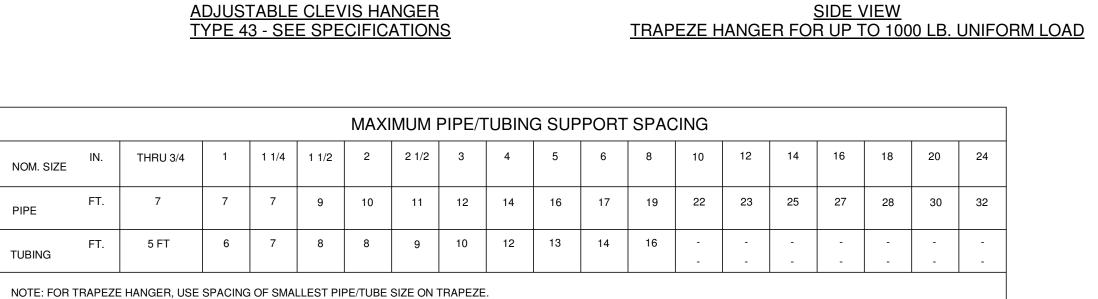

1" MAX ---


TYPICAL PIPE HANGERS NOT TO SCALE

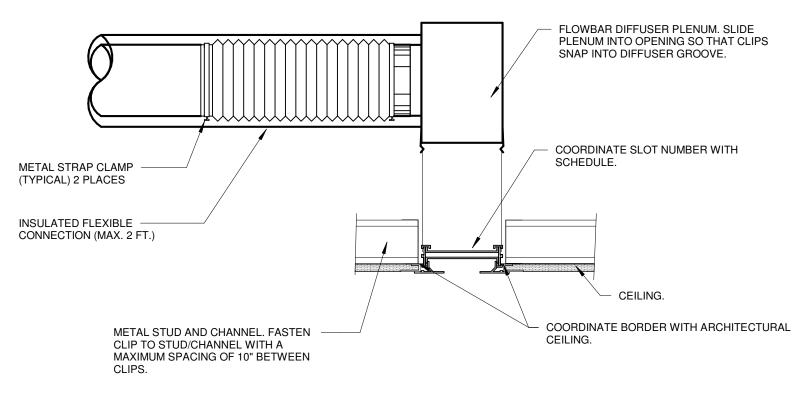

NOTES:

1. SEE ARCHITECTURAL DRAWINGS FOR ADDITIONAL INFORMATION REGARDING OPENING IN

LINEAR DIFFUSER DETAIL

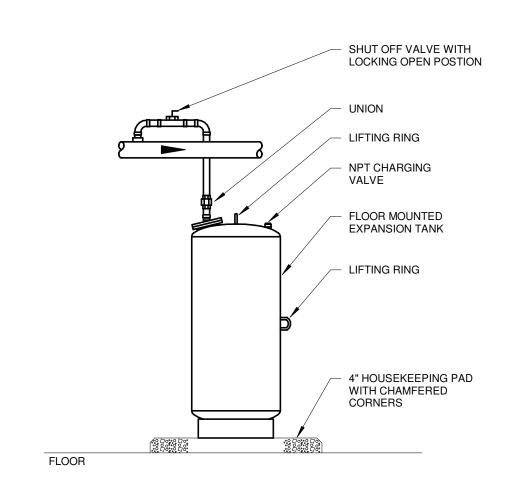

EXPANSION TANK (FLOOR MOUNTED)